


# Terrence Cheng, President

FACILITIES DEPARTMENT 61 WOODLAND STREET HARTFORD, CT 06105

PROJECT NO. BI-CTC-649

ADA / OCR RESTROOM UPGRADES, PHASE 2A ASNUNTUCK COMMUNITY COLLEGE

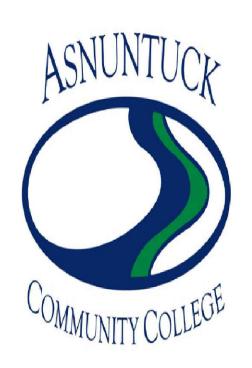

170 ELM STREET, ENFIELD, CT 06082

DCS BUILDING #12677

ARCHITECT
FRIAR ARCHITECTURE, INC.
21 TALCOTT NOTCH ROAD
FARMINGTON, CT 06032





# LIST OF DRAWINGS

COVER	
R1.1	REFERENCE SHEET / CODE INFORMATION
R1.2	REFERENCE SHEET
A1.1	FLOOR PLAN / DEMOLITION PLAN
A2.1	REFLECTED CEILING PLAN
A3.1	INTERIOR ELEVATIONS
A4.1	FINISH PLAN, SCHEDULE & DETAILS
A5.1	DOOR SCHEDULE & DETAILS
MEP1.1	MEP FLOOR PLAN - DEMOLITION PLAN

# **ABBREVIATIONS**

### **ABBREVIATIONS**

ABOVE FINISH FLOOR	A.F.F.	JOINT	JT.
ACOUSTIC TILE	A.C.T.	LAVATORY	LAV.
ALTERNATE ANGLE	ALT. L	LIGHTING	LTG.
ARCHITECTURAL/ARCHITECT	=	MANULEACTURER	MFR.
AT	@	MANUFACTURER MASONRY	
		MASONRY OPENING	MAS. M.O.
BOARD BOTTOM OF	BD.	MATERIAL	MATL.
BUILDING	B/O BLDG.	MAXIMUM	MAX.
Dolland	<i>B B B B B B B B B B</i>	MECHANICAL	MECH.
CEILING	CLG.	MINIMUM	MIN.
CENTER	CTR.	MISCELLANEOUS	MISC.
CERAMIC FLOOR TILE	CTD	ON CENTER	O.C.
CERAMIC TILE BASE CERAMIC WALL TILE	CTB CWT		
CONTROL OR	CVVI	PAINT	Р
CONSTRUCTION JOINT	C.J.	PAINTED	PTD.
CONTINUOUS	CONT.	PLASTIC LAMINATE	P.LAM
CORRIDOR	CORR.	PLYWOOD	PLYWD
DEMOLITION	DEMO	PREFABRICATED	PREFA
DEMOLITION DIMENSION	DEMO. DIM.	POINT	PT.
DOWN	DN.		
	DIV.	RADIUS	RAD.
FLECTRIC / FLECTRICAL	51.50	REINFORCED / REINFORCING	REINF.
ELECTRIC / ELECTRICAL	ELEC. EL.	REQUIRED REVISION, REVISED	REQ'D. REV.
ELEVATION ELEVATOR	ELEV.	ROOM	RM.
EQUAL	EQ.	KOOW	TAIVI.
EXISTING	EXIST.	SCHEDULE	SCHED
EXPANSION JOINT	E.J.	SECTION	SECT.
EXPANSION	EXP.	SHEET	SHT.
EXPANSION JOINT	E.J.	SIMILAR	SIM.
FEET, FOOT	FT.	SPECIFICATIONS	SPEC.
FINISH, FINISHED	FIN.	SQUARE FEET (FOOT)	S.F.
FIXTURE	FIXT.	STAINLESS STEEL STANDARD	ST. STL STD.
FLOOR	FL.	STEEL	STL.
FLOOR DRAIN	FD.	STORAGE	STOR.
GYPSUM BOARD	GYP.BD.	STRUCTURAL	STRUC
		SOLID SURFACE	SS
HANDICAPPED	H.C.	SUSPEND, SUSPENSION	SUSP.
HEIGHT HOLLOW METAL	HGT. HM.	SYSTEM	SYS.
HORIZONTAL	HORIZ.		
		TO BE DETERMINED	TBD
INCH OR INCHES INFORMATION	IN. OR " INFO.	TEMPERATURE/TEMPORARY	TEMP.
INSULATION	INSUL.	TOP OF	T/O
INTERIOR	INT.	TYPICAL	TYP.
		UNDERWRITER'S LABORATORIES	U.L.
		VERIFY IN FIELD	V.I.F.
		VERTICAL	VERT.
		VINYL COMPOSITION THE	V.A.T.
		VINYL COMPOSITION TILE	V.C.T.

WATER CLOSET

F Rating - 3 Hr T Ratings - 0, 2 & 3 Hr (See Item 2)

FIRESTOP SEALANT

CONNECTION

FIRESTOP —


SECTION A-A

COLLAR

PENETRATING —

# SYMBOLS LEGEND


### **ARCHITECTURAL SYMBOLS**

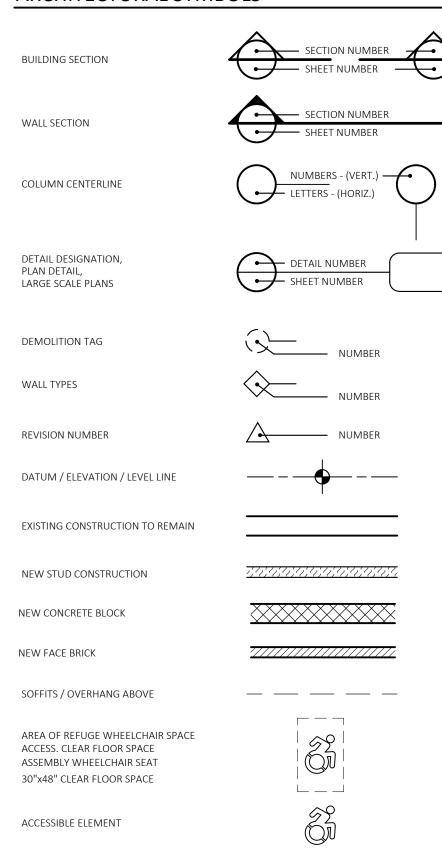

### ARCHITECTURAL MATERIALS

C.M.U.		PLYWOOD	
CONCRETE	· · · · · · · · · · · · · · · · · · ·	RIGID INSULATION	
FACE BRICK		ROUGH WOOD (CONTINUOUS)	
FACE GRAIN		ROUGH WOOD (INTERRUPTED)	
FINISHED WOOD		BATT INSULATION	
GYPSUM BOARD		PLASTER	
ACOUSTICAL TILE		SHEATHING INSUL.	
ALUMINUM		STEEL	
CAST STONE		ROOF BALLAST	* * * * * * * * * * * * * * * * * * * *

F-RATING = 3 HR. T-RATING = 0 HR. L-RATING AT AMBIENT = LESS THAN 1 CFM/SG. FT. L-RATING AT 400° F = 4CFM/SQ. FT.

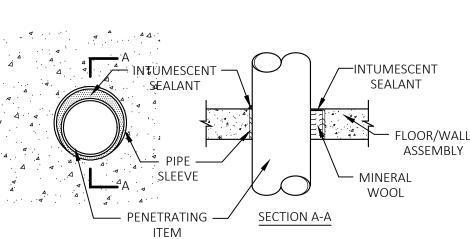

# UL RATED DETAILS

PENETRATING

W.C.

# **NOTES**

### CONSTRUCTION NOTES

- 1. ALL WORK SHALL BE PERFORMED IN STRICT ACCORDANCE WITH ALL CURRENT LISTED CODES SHOWN ON SHEET R1.1.
- 2. DO NOT SCALE DRAWINGS. THE CONTRACTOR SHALL BE RESPONSIBLE FOR OBTAINING CLARIFICATION OF DIMENSIONS FROM THE ARCHITECT BEFORE CONTINUING WITH CONSTRUCTION.
- 3. CONTRACT DRAWINGS MAY VARY FROM ACTUAL FIELD CONDITIONS. CONTRACTOR SHALL CORRECT DIMENSIONS OF ALL MATERIALS TO CARRY OUT THE INTENT OF THE CONTRACT DRAWINGS. VERIFY ALL DIMENSIONS AND EXISTING CONDITIONS IN FIELD BEFORE ORDERING ANY MATERIALS. CONTRACTOR SHALL NOTIFY ARCHITECT PROMPTLY OF ANY CRITICAL DISCREPANCIES BEFORE PROCEEDING WITH WORK.
- 4. ALL NEW WORK SHALL BE IMPLEMENTED SO AS TO PROVIDE A SMOOTH AND CONTINUOUS SURFACE WITH ALL EXISTING CONDITIONS. CONTRACTOR SHALL BE RESPONSIBLE FOR ALL WORK NECESSARY TO ACHIEVE THIS REQUIREMENT, EVEN THOUGH PROCEDURES ARE NOT DETAILED FOR EACH SPECIFIC CONDITION OR COMBINATION OF CONDITIONS. QUALITY OF WORKMANSHIP, MATERIALS AND FINISHES SHALL BE EQUAL TO THE LEVEL ESTABLISHED FOR SIMILAR CONSTRUCTION, EXCEPT WHERE EXISTING APPEARANCE IS TO BE MATCHED TO ACHIEVE CONTINUITY.
- 5. CUTTING AND PATCHING SHALL BE THE RESPONSIBILITY OF THE TRADE WHOSE WORK RESULTS IN THE NEED FOR CUTTING AND PATCHING UNLESS A SPECIFIC CONTRACTOR IS CALLED OUT ON THE DRAWINGS. ALL HOLES LEFT BY REMOVING MECHANICAL, PLUMBING AND ELECTRICAL EQUIPMENT, ETC. SHALL BE PATCHED.
- 6. UNLESS OTHERWISE NOTED OR DIMENSIONED, NEW PARTITIONS SHALL BE CENTERED ON BUILDING COLUMN GRID OR WINDOW MULLIONS.
- 7. CONTRACTOR SHALL PROVIDE WOOD BLOCKING AT WALLS AS REQUIRED TO SUPPORT PIPING, CABINETS TV BRACKETS AND RELATED ITEMS.
- 8. ALL EGRESS DOORS SHALL BE NON-LOCKING IN DIRECTION OF TRAVEL.

### **DEMOLITION NOTES**

- 1. ALL WORK SHALL BE PERFORMED IN STRICT ACCORDANCE WITH ALL CURRENT LISTED CODES SHOWN ON SHEET R1.1.
- 2. THE DEMOLITION PLANS ARE DIAGRAMMATIC AND INTENDED TO SHOW THE GENERAL EXTENT OF THE WORK ONLY. THE CONTRACTOR SHALL INCLUDE ALL DEMOLITION WORK REQUIRED TO ACCOMPLISH THE INTENT OF THE PLANS AND SPECIFICATIONS.
- 3. ALL DEMOLISHED ITEMS SHALL BE REMOVED FROM BUILDING / SITE UNLESS NOTED OTHERWISE. COORDINATE WITH OWNER FOR DELIVERY OF ITEMS NOTED TO REMAIN OWNERS PROPERTY. THE PROJECT SITE / BUILDING SHALL BE CLEANED OF DEBRIS ON A DAILY BASIS.
- 4. CONTRACTOR SHALL BE RESPONSIBLE FOR SHORING AND SUPPORT (TEMPORARY OR PERMANENT) FOR ALL PORTIONS OF CONSTRUCTION DURING DEMOLITION AND CONSTRUCTION.
- 5. ALL ABANDONED MECHANICAL / ELECTRICAL / PLUMBING LINES SHALL BE CAPPED OFF BEHIND FINISHES, UNLESS NOTED OTHERWISE. REFER TO MECHANICAL / ELECTRICAL / PLUMBING DRAWINGS FOR ADDITIONAL INFORMATION.
- 6. CONTRACTOR SHALL SAWCUT ALL MASONRY OR CONCRETE OPENINGS INDICATED. MASONRY SHALL BE TOOTHED IN AND / OR RETURNED TO FINISHED OPENING.
- 7. ALL OPENINGS WHERE EXISTING CONSTRUCTION HAS BEEN REMOVED, AND WHICH ARE NOT NOTED TO REMAIN, SHALL BE FILLED AND / OR PATCHED TO MATCH THE ADJACENT EXISTING OR NEW FINISH, INCLUDING ANY FIRE RATINGS REQUIRED.
- 8. ALL AREAS OF FLOORS, WALLS AND CEILINGS DISTURBED BY DEMOLITION SHALL BE FILLED, PATCHED OR OTHERWISE REFINISHED TO MATCH EXISTING OR NEW FINISH AS DESIGNATED, INCLUDING ALL REQUIRED RATINGS.
- 9. CONTRACTOR MUST VERIFY LOCATIONS OF ALL EXISTING STRUCTURAL, MECHANICAL, PLUMBING & ELECTRICAL ELEMENTS PRIOR TO START OF DEMOLITION.

# GENERAL NOTES

DIMENSION CRITERIA
 FROM FACE OF METAL STUD TO FACE OF METAL STUD.
 FROM FACE OF METAL STUD TO FACE OF CONCRETE MASONRY UNIT.
 FROM FACE OF CONCRETE MASONRY UNIT TO FACE OF CONCRETE MASONRY UNIT.

# FIRESTOPPING NOTES:

ALL PENETRATION FIRESTOPPING IS REQUIRED FOR ALL BUILDING LEVELS PERTAINING TO THE WORK ASSOCIATED WITH THESE CONTRACT DOCUMENTS. REFER TO SPECIFICATION SECTION 078413 - PENETRATION FIRESTOPPING, FIRE RATING PLAN, ASSOCIATED NOTES & ALL DRAWINGS FOR EXTENT OF WORK.

# CODE INFORMATION

Da	te of Original Construction 1969 est. Renovation	2017 - New Manufacturing Technology Center
1.	GROUP CLASSIFICATION (Primary)	B - BUSINESS A - ASSEMBLY F - FACTORY
	(Incidental)	S - STORAGE
<u>)</u> .	CONSTRUCTION TYPE	
	Actual Type Provided	2B
	New Construction	None
3.	WORK AREA	
	(WORK AREA) Existing Roof Area to be Replaced	N/A
1.	FIRE-RESISTANCE RATED REQUIREMENTS FOR BUILDING ELEMENTS (Tab	ole 601)
		2B
	Primary structural frame	0 Hr(s)
	Bearing walls: Exterior Interior	0 Hr(s) See Table 602 0 Hr(s)
	Nonbearing walls and partitions (Exterior)	- Hr(s) See Table 602
	Nonbearing walls and partitions (Interior)	0 Hr(s)
	Floor Construction and associated secondary members	0 Hr(s)
	Roof Construction and associated secondary members	0 Hr(s)
		Refer to Table 601 for all footnotes
5.	SPRINKLER PROTECTION X Provided	

#### CURRENT 2023 STATE BUILDING CODE:

### CODE INFORMATION - CURRENT CODES

2021 International Building Code \*
2021 International Mechanical Code \*
2021 International Mechanical Code \*
2021 International Existing Building Code \*
2021 International Plumbing Code \*
2021 International Energy Conservation Code \*
2020 National Electrical Code (NFPA 70) \*
2021 Installation of Sprinkler Systems (NFPA 13)
2021 Life Safety Code (NFPA 101) \*
2021 Fire Code (NFPA 1) \*

\* With Connecticut Amendments and General Statute requirements

# INTERNATIONAL EXISTING BUILDING CODE

#### THE INTERNATIONAL EXISTING BUILDING CODE (IEBC)

buildings shall comply with one of the methods listed

CHAPTER 3: PROVISIONS FOR ALL COMPLIANCE METHODS - Section 301 ADMINISTRATION Section 301.1 Applicability - The alteration of all existing buildings shall comply with Section 301.3. The provisions of Sections 302 through 309 shall apply to all alterations

regardless of compliance method.

Section 301.3 Alteration, addition or change of occupancy - The alteration of all existing

Section 301.3.2 Work area compliance method - Alterations complying with the applicable requirements of Chapters 6 through 12 of this code shall be considered in compliance with the provisions of this code.

Section 302 General Provisions

Section 306 Accessibility for Existing Buildings , In particular 306.1 Scope, 306.2 Design, 306.7 Alterations

CHAPTER 6: CLASSIFICATION OF WORK - Section 602 ALTERATION LEVEL 1.

602.1 Scope - Level 1 alterations include the removal and replacement or the covering of existing materials, elements, equipment, or fixtures using new materials, elements, equipment, or fixtures that serve the same purpose.

602.2 Application - Level 1 Alterations shall comply with the provisions of Chapter 7

CHAPTER 7: The Alteration must comply with Chapter 7, Alterations - Level 1:

Section 701 General - In Particular Section 701.1 Scope, Section 701.2 Conformance.


Section 702 Building Elements and Materials - In Particular Section 702.1 Interior Finishes, 702.2 Interior Floor Finish, 702.3 Interior Trim, 702.7 Materials and Methods

Section 703 Fire Protection - In Particular Section 703.1 General


Section 704 Means of Egress - In Particular Section 704.1 General

Section 708 Energy Conservation - In Particular Section 708.1 Minimum Requirements

By complying with the applicable requirements of Chapters 7 of the 2021 International Existing Building Code (IEBC) this alteration shall be considered in compliance.

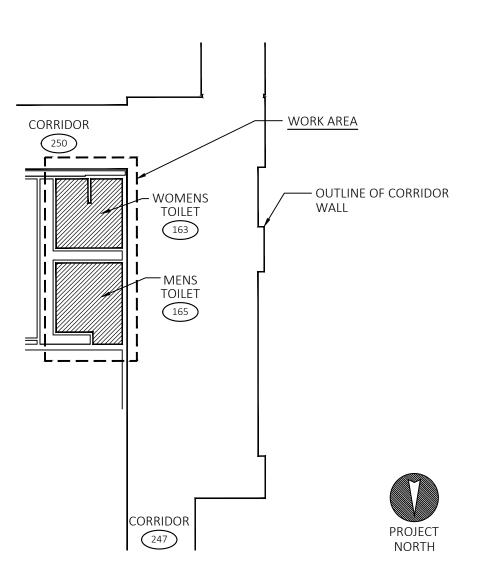

# WORK AREA PLAN

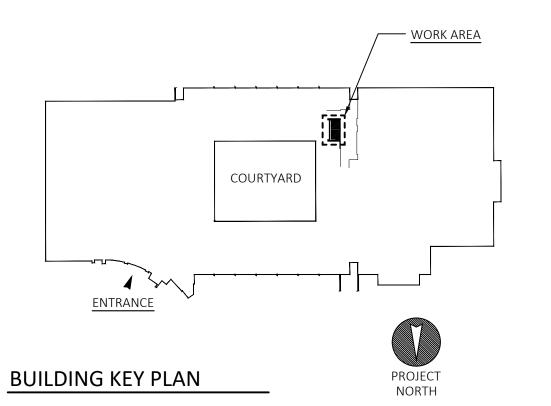



	ERENC	CE SHEET / DRMATION REVISIONS	CONNETICUT STATE COLLEGES AND UNIVERSITIES FACILITIES PLANNING						
mark	date	description	FRIAR ARCHITECTURE, INC.  21 TALCOTT NOTCH ROAD FARMINGTON, CONNECTICUT 06032	date: 03-14-2023 scale As indicated production leader PEH					
			BI-CTC-649 ASNUNTUCK COMMUNITY COLLEGE, ADA / OCR RESTROOM UPGRADES, PHASE 2A 170 ELM STREET ENFIELD, CONNECTICUT 06082	project manager: PEH project architect: RWR peer reviewer: - drawing no.					

R1.1





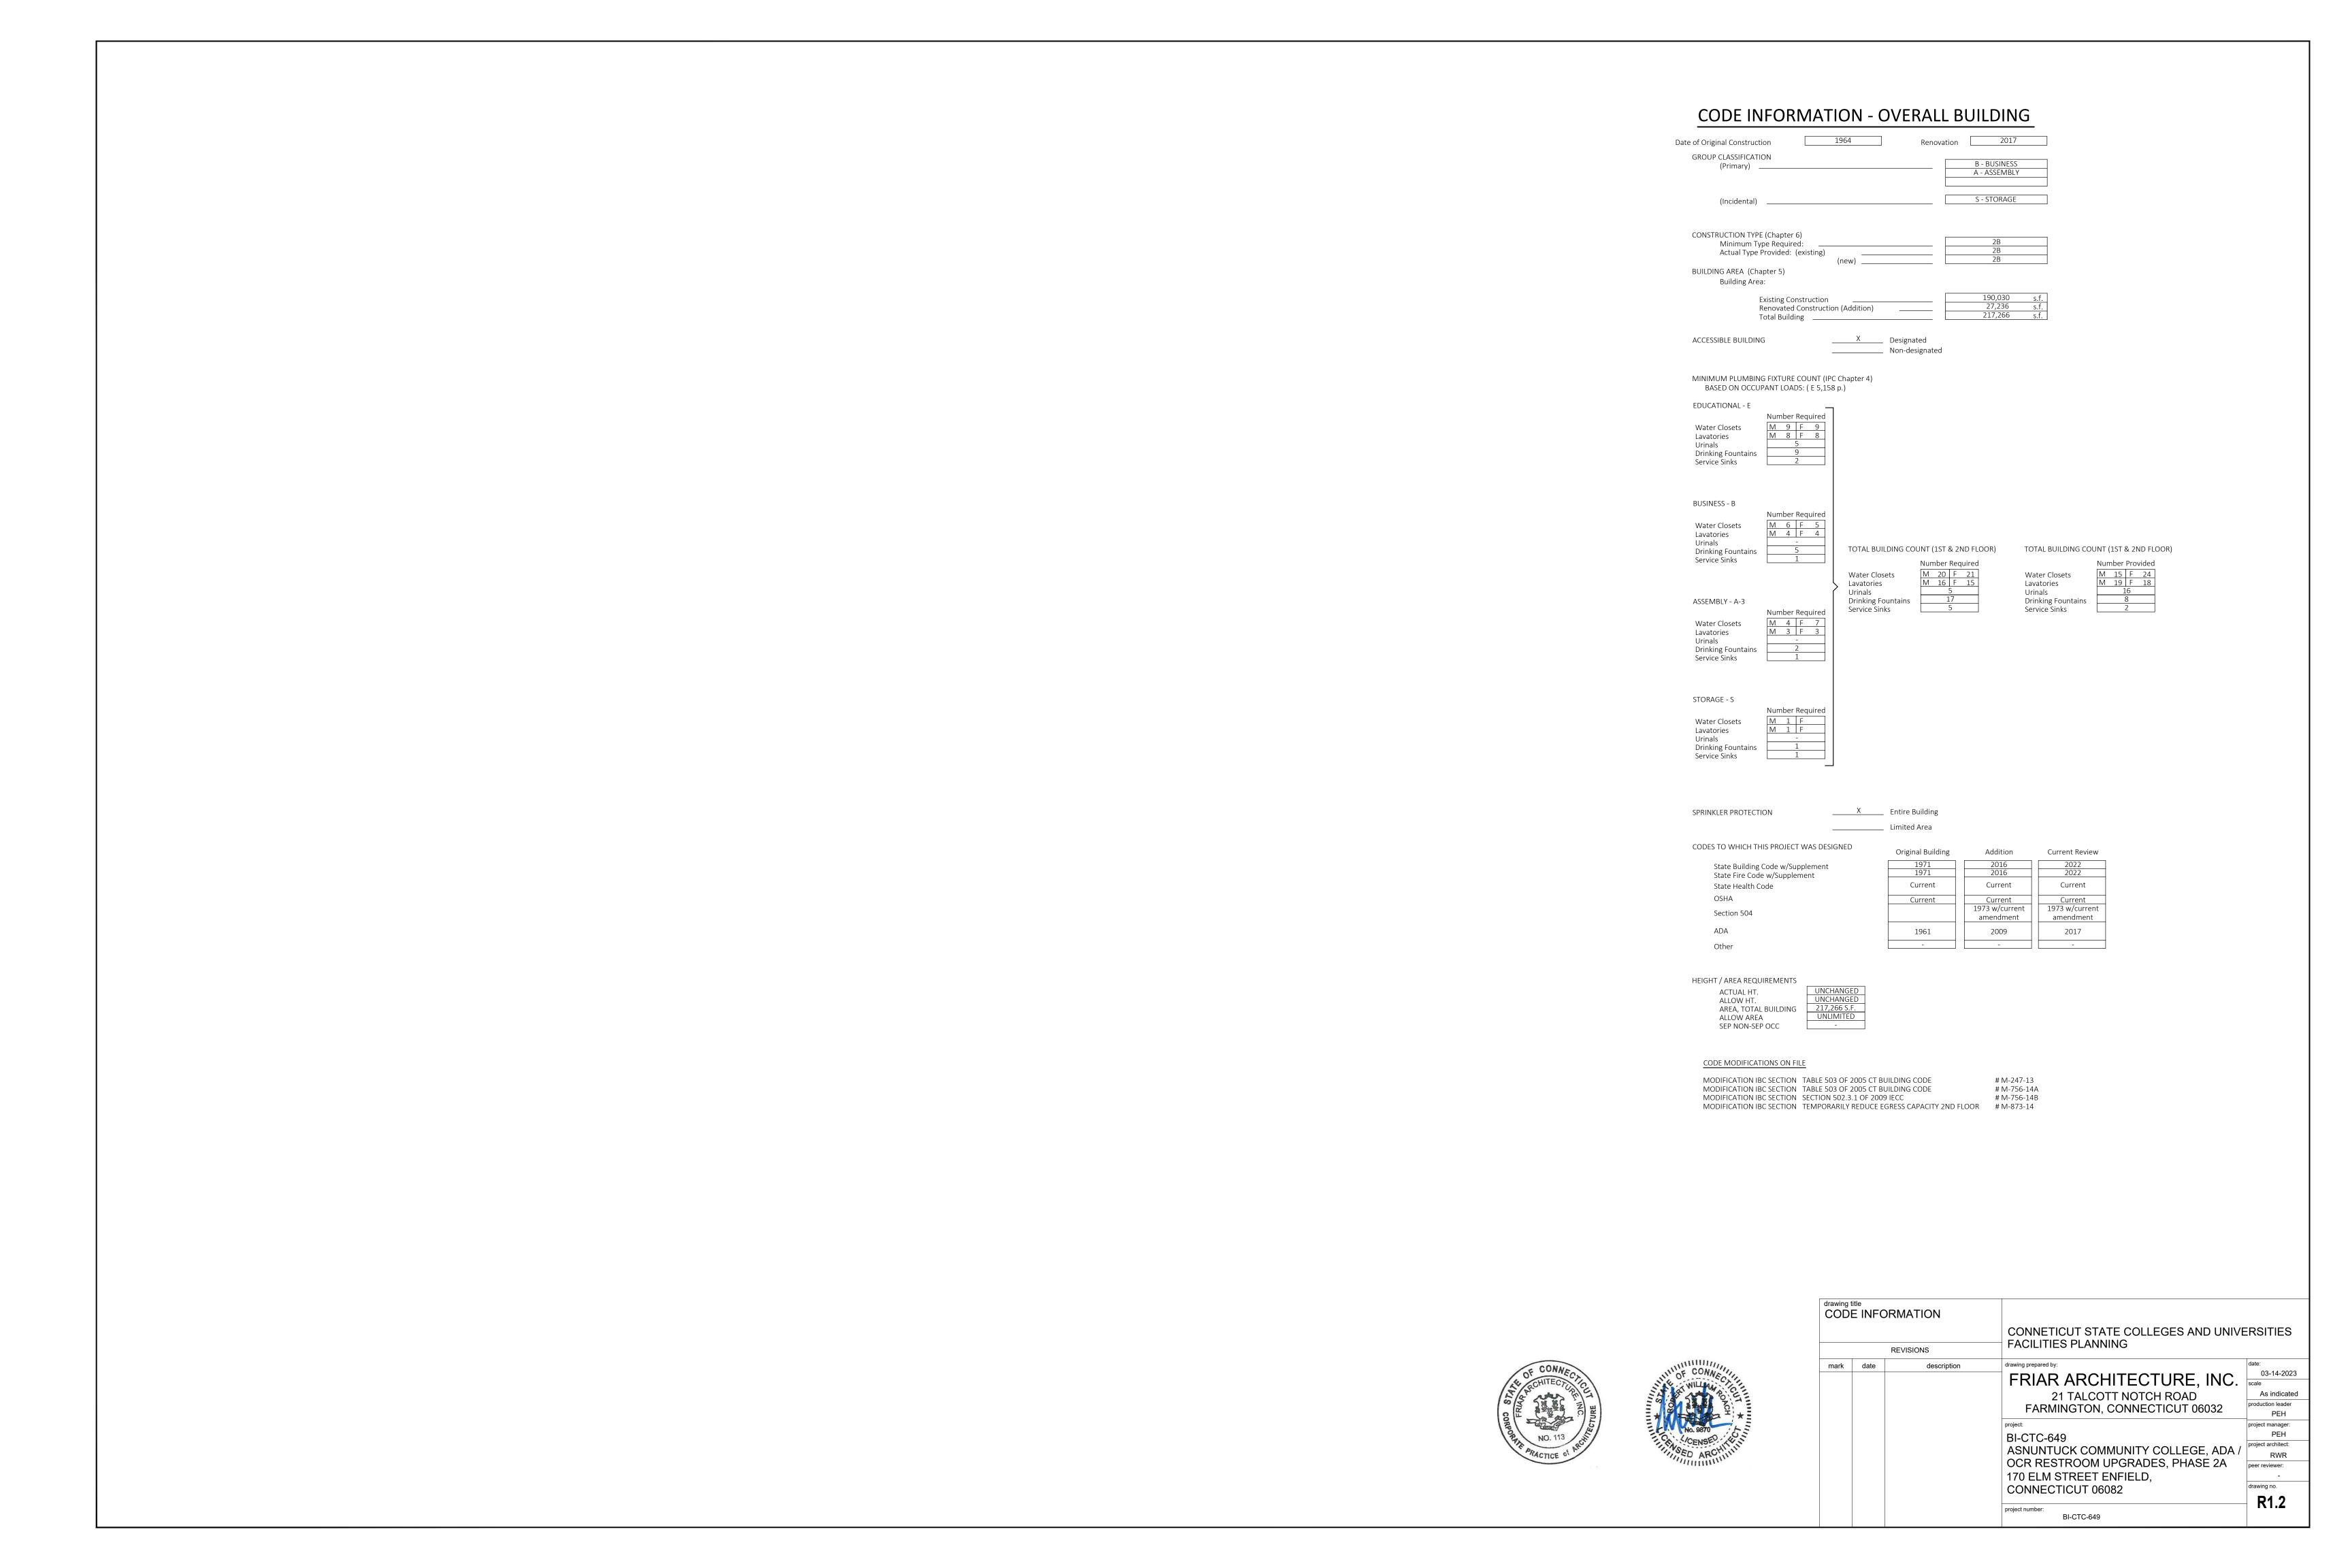

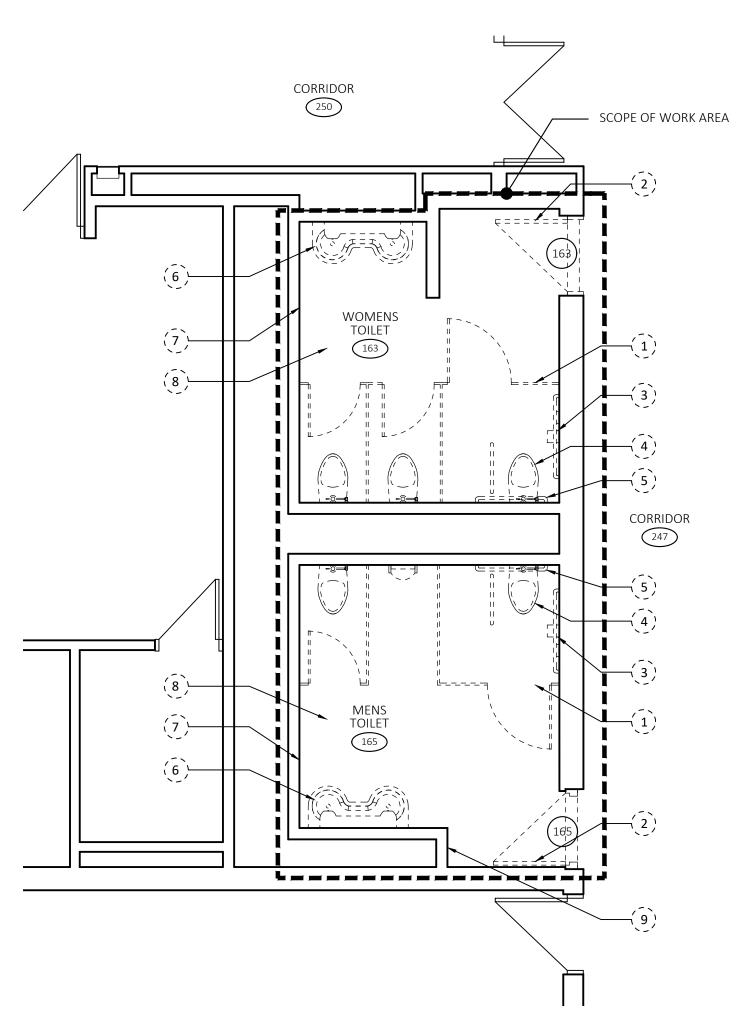

# **DEMOLITION NOTES:**

- REMOVE ALL EXISTING TOILET PARTITIONS & ASSOCIATED HARDWARE FOR NEW FLOOR FINISH. REFER TO PLANS & SPECIFICATIONS FOR ADDITIONAL
- REMOVE EXISTING DOOR, DOOR FRAME & ASSOCIATED HARDWARE. PREP MASONRY OPENING FOR NEW DOOR & FRAME.
- REMOVE ALL EXISTING WALL MOUNTED TOILET ROOM ACCESSORIES: MIRRORS, SHELVES, SOAP DISPENSERS, TOILET PAPER DISPENSERS, TOWEL DISPENSERS, TOWEL HOOKS & WALL MOUNTED HARDWARE WITHIN BATHROOM AREAS. SALVAGE & TURN OVER TO OWNER FOR THEIR USE.
- REMOVE EXISTING WALL MOUNTED TOILET FIXTURE. REFER TO MEP DRAWINGS FOR ALL EXISTING ELECTRICAL / PLUMBING FIXTURES SCHEDULED FOR REMOVAL
- REMOVE EXISTING GRAB BARS LOCATED WITHIN THE TOILET ROOM AREAS. SALVAGE FOR OWNERS USE.
- REMOVE EXISTING WALL MOUNTED SINK FIXTURE. REFER TO MEP DRAWINGS FOR ALL EXISTING ELECTRICAL / PLUMBING FIXTURES SCHEDULED FOR REMOVAL
- REMOVE EXISTING CERAMIC TILE WALL SYSTEMS AND BASE TO EXISTING MASONRY, PREP EXISTING MASONRY WALLS FOR INSTALLATION OF NEW CERAMIC TILE WALL SYSTEM (CWT).
- REMOVE EXISTING CERAMIC TILE FLOORING TO EXISTING CONCRETE FLOOR SYSTEM. PREP EXISTING FLOOR SYSTEMS PER PORCELAIN TILE SYSTEM REQUIREMENTS FOR INSTALLATION OF NEW PORCELAIN TILE FLOOR SYSTEM (PT).
- REMOVE COVERS & PROTECT, EXISTING PLUMBING CHASE ACCESS PANEL & WALL MOUNTED MECHANICAL GRILLE. CLEAN & PREP FOR EPOXY PAINT

### GENERAL DEMOLITION NOTES

PREP ALL CMU WALL AREAS FOR WALL FINISHES, TYP.


PREP ALL FLOOR AREAS FOR NEW FLOORING, TYP.

REMOVE & SALVAGE ALL EXISTING TOILET ACCESSORIES SCHEDULED FOR DEMO. CONSULT OWNER & TURN OVER TO THE OWNER ALL TOILET ACCESSORIES DEEMED ACCEPTABLE, TYPICAL AT ALL BATHROOMS. CONTRACTOR TO DISPOSE OF TOILET ACCESSORIES NOT ACCEPTABLE TO THE OWNER

# DEMO - FLOOR PLAN

				TO	ILE <sup>-</sup>	ΓR	) )	M A	\CC	ESS	SOF	RIES	SC	HED	UL	<u>.E</u>			
							MISCELI	_ANEOUS	5										LEGEND
ROOM NUMBER AREA DESIGNATION	ROOM OR AREA NAME	WALL MIRRORS - 54" W X 36" H	ELECTRIC HAND DRYERS	NAPKIN DISPOSALS	ADA STALL TOILET PAPER DISPENSERS	HOOKS @ COMPARTMENT DOORS		JUMBO TOILET PAPER DISPENSERS	SOAP DISPENSERS	NEEDLE DISPOSAL UNITS	PAPER TOWEL DISPENSERS	PLASTIC SIGN HOLDERS (BACK OF STALL DOOR)	BASKETS @ COMPARTMENTS	TOILET SEAT COVERS		TAMPON/NAPKIN DISPENSERS	FREE STANDING TRASH RECEPTACLES	ADDITIONAL RESTROOM SIGNAGE	<ul> <li>INDICATES CONTRACTOR PROVIDED &amp; CONTRACTOR INSTALLED</li> <li>INDICATES OWNER PROVIDED &amp; CONTRACTOR INSTALLED</li> <li>REUSE EXISTING - REMOVE &amp; REINSTALL ON NEW FINISHES</li> <li>INDICATES OWNER PROVIDED AND OWNER INSTALLED</li> <li>COORDINATE INSTALLATION OF ALL TOILET ACCESSORIES W/ OWNER &amp; ARCHITECT</li> </ul>
163	WOMENS TOILET			•				9			•	9	•			•	0	0	1
165	MENS TOILET	•	•	•	•	•		0	0	0	0	0	0	•		-	0	0	
ATTAC	CH W/ DOUBLE SIDED FOAM TAPE								9	9				•					

REFER TO ELEVATION 11/A3.1 INTERIOR ELEVATIONS FOR ELEVATION AT STANDARD STALL DOOR. ELEVATION SHOWS LOCATION AND HEIGHTS OF COAT HOOK, SIGN HOLDER & BASKET AT STANDARD TOILET STALL DOOR. ADA MOUNTING HIEGHTS TO BE PER ACCESSIBLE MOUNTING HEIGHT SCHEDULE.

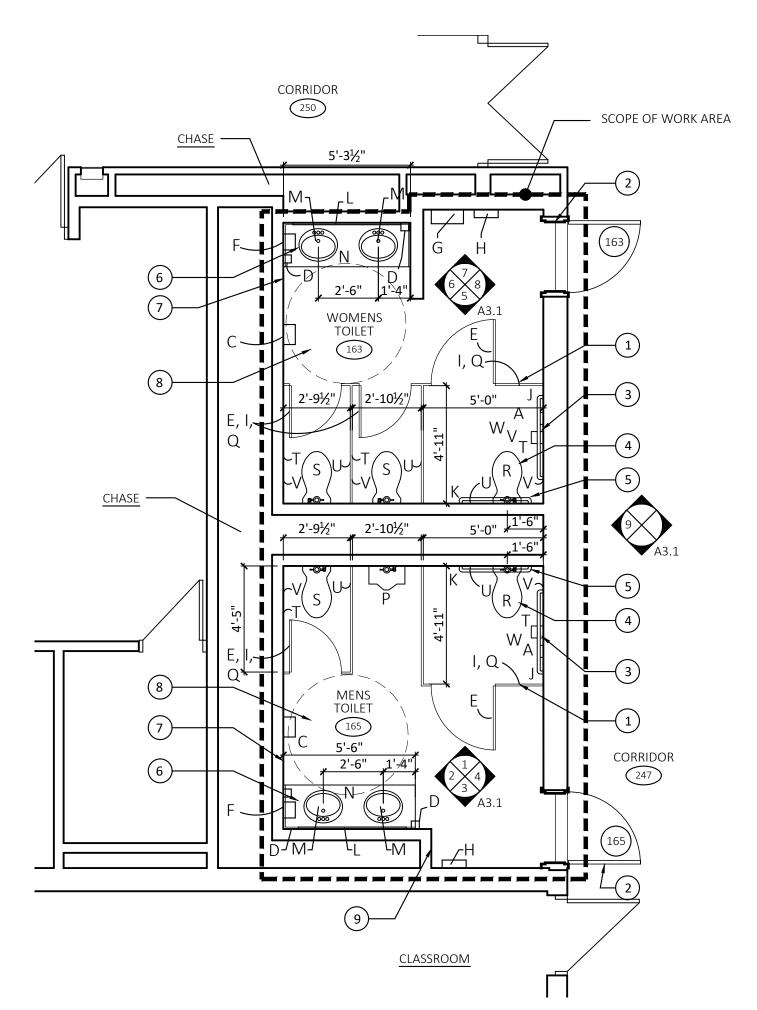



# NEW WORK - FLOOR PLAN

REFER TO DRAWING NO. A3.1 INTERIOR ELEVATIONS FOR INTERIOR ELEVATIONS, TOILET ACCESSORIES MOUNTING HEIGHT SCHEDULE & ADULT GRAB BAR MOUNTING LOCATIONS FOR ADDITIONAL INFORMATION. REFER TO SPECIFICATION SECTION 102800 TOILET & BATH ACCESSORIES FOR TYPES & INFORMATION.

PRE-INSTALL MEETING & ASSOCIATED MOCK UP REQUIRED PRIOR TO INSTALLATION OF ALL TOILET ACCESSORIES.

REFER TO ELEVATION DRAWING NO. 11/A3.1 FOR ADDITIONAL INFORMATION ON BACK OF STANDARD COMPARTMENT STALL DOOR COORDINATION FOR COAT HOOK, SIGN HOLDER & BASKET.

# **CONSTRUCTION NOTES:**

- FURNISH & INSTALL NEW TOILET PARTITIONS & ASSOCIATED HARDWARE. REFER TO PLANS & SPECIFICATIONS FOR ADDITIONAL INFO.
- FURNISH & INSTALL NEW DOOR, DOOR FRAME & ASSOCIATED HARDWARE, REFER TO SPECIFICATIONS & DOOR SCHEDULE. INSTALL NEW EPOXY PAINT SYSTEM REFER TO FINISH SCHEDULE & SPECIFICATIONS.
- FURNISH & INSTALL WALL MOUNTED TOILET ROOM ACCESSORIES: MIRRORS, SHELVES, SOAP DISPENSERS, TOILET PAPER DISPENSERS, TOWEL DISPENSERS, & WALL MOUNTED HARDWARE WITHIN BATHROOM AREAS. REFER TO SPECIFICATIONS & MOUNTING HEIGHT SCHEDULE FOR TOILET ACCESSORIES ON A3.1.
- FURNISH & INSTALL WALL MOUNTED TOILET FIXTURE. REFER TO MEP DRAWINGS FOR ALL ELECTRICAL / PLUMBING FIXTURES SCHEDULED FOR INSTALLATION
- FURNISH & INSTALL GRAB BARS IN THE TOILET ROOM AREAS. REFER TO SPECIFICATIONS & MOUNTING HEIGHT SCHEDULE FOR TOILET ACCESSORIES.
- FURNISH & INSTALL NEW COUNTERTOP AND UNDER COUNTER MOUNTED SINK FIXTURE. REFER TO CASEWORK DETAILS & FINISH SCHEDULE. REFER TO MEP DRAWINGS FOR ALL ELECTRICAL / PLUMBING FIXTURES SCHEDULED.
- FURNISH & INSTALL NEW CERAMIC TILE WALL (CWT) SYSTEM AND ASSOCIATED CERAMIC TILE BASE (CTB) AT EXISTING MASONRY WALL CONSTRUCTION. PREP EXISTING MASONRY WALL SYSTEM PER CERAMIC TILE SYSTEM REQUIREMENTS FOR INSTALLATION OF CERAMIC TILE WALL AND BASE. REFER TO FINISH SCHEDULE.
- FURNISH & INSTALL PORCELAIN TILE (PT) FLOORING SYSTEM AT EXISTING CONCRETE FLOOR CONSTRUCTION. PREP EXISTING FLOOR SYSTEMS PER PORCELAIN TILE SYSTEM REQUIREMENTS FOR INSTALLATION OF NEW PORCELAIN TILE FLOOR SYSTEM. REFER TO FINISH SCHEDULE
- PROTECT PAINT EXISTING PLUMBING CHASE ACCESS PANELS & WALL MOUNTED DIFFUSERS, TOUCH UP PAINT FINISH AS REQUIRED

# TOILET ROOM ACCESSORIES LEGEND


- A. CALL FOR AID
- N/A
- ELECTRIC HAND DRYER SOAP DISPENSER
- COAT HOOK / BUMPER
- PAPER TOWEL DISPENSER
- SANITARY NAPKIN DISPENSER NEEDLE DISPOSAL UNIT
- HANGING BASKET **GRAB BAR**
- GRAB BAR
- MIRROR (SEE DWGS. FOR SIZE) SINK ACCESSIBLE VANITY
- P. URINAL (ACCESSIBLE HEIGHT) Q. SIGN HOLDER
- WATER CLOSET (ACCESSIBLE HEIGHT) WATER CLOSET (STANDARD HEIGHT)
- TOILET PAPER DISPENSER U. TOILET SEAT COVER DISPENSER
- V. SANITARY NAPKIN DISPOSAL
- W. VERTICAL GRAB BAR

# GENERAL NOTE

PROVIDE FLOOR PROTECTION AT EXISTING CORRIDOR. REFER TO FINISH SCHEDULE FOR ADDITIONAL INFORMATION

PROVIDE TEMPORARY PROTECTION FOR EXISTING FIRE SUPPRESSION

REFER TO CEILING PLAN FOR DEMOLITION AND NEW CEILING SYSTEM.

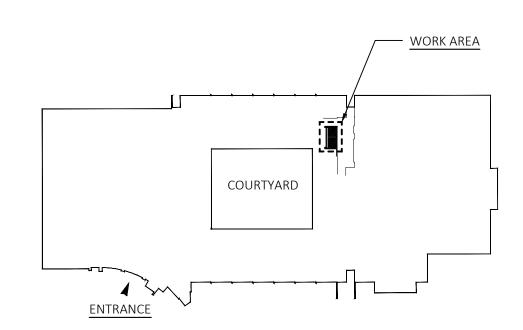

**BUILDING KEY PLAN** 



drawing t	itle			
FLOC	R PLA	N/		
DEMO	OLITIO	N PLAN	CONNETICUT STATE COLLEGES AND UNIVE	ERSITIES
		REVISIONS	FACILITIES PLANNING	
mark	date	description	drawing prepared by:	date:
		·	FRIAR ARCHITECTURE, INC.	03-14-2023
			I MAN ANGITTEGIONE, INC.	scale
			21 TALCOTT NOTCH ROAD	As indicated
			FARMINGTON, CONNECTICUT 06032	production leader
			17444411401014, 0014142011001 00002	PEH
			project:	project manager:
			BI-CTC-649	PEH
			ASNUNTUCK COMMUNITY COLLEGE, ADA /	project architect:
			OCR RESTROOM UPGRADES, PHASE 2A	RWR
			,	peer reviewer:
			170 ELM STREET ENFIELD,	-
			CONNECTICUT 06082	drawing no.
				<b>▲1.1</b>
			project number:	
			BI-CTC-649	





### CEILING DEMOLITION NOTES: KEYED TO DEMO CEILING PLAN

KEYED TO CEILING PLAN



REMOVE EXISTING CEILING MOUNTED EQUIPMENT & DEVICES, REUSE AS SCHEDULED. REFER TO MEP DRAWINGS FOR ADDITIONAL INFO

# CEILING TYPE SCHEDULE

C-1 2' X 2' ACOUSTICAL CEILING TILE.


BASIS OF DESIGN: ARMSTRONG ULTIMA HIGH NRC ITEM NO. 1910 - 15/16" SQUARE LAY-IN, FINE TEXTURE PANEL SIZE 24" X 24" X 7/8" IN 15/16" PRELUDE XL EXPOSED TEE CEILING GRID.

# **CEILING GENERAL NOTES:**

ALL WORK SHALL BE PERFORMED IN STRICT ACCORDANCE WITH ALL NATIONAL, STATE, LOCAL CODES & ORDINANCES.

REFER TO M/E/P DRAWINGS FOR CEILING FIXTURE TYPES, REQUIRED WORK, AND FOR OTHER CEILING MOUNTED EQUIPMENT NOT INDICATED ON THESE DRAWINGS.


CUT CEILING TILES AS REQUIRED FOR INSTALLATION AROUND NEW OR EXISTING PIPING, FIRE ALARM EQUIPMENT, HANGER RODS, CONDUIT, ETC.

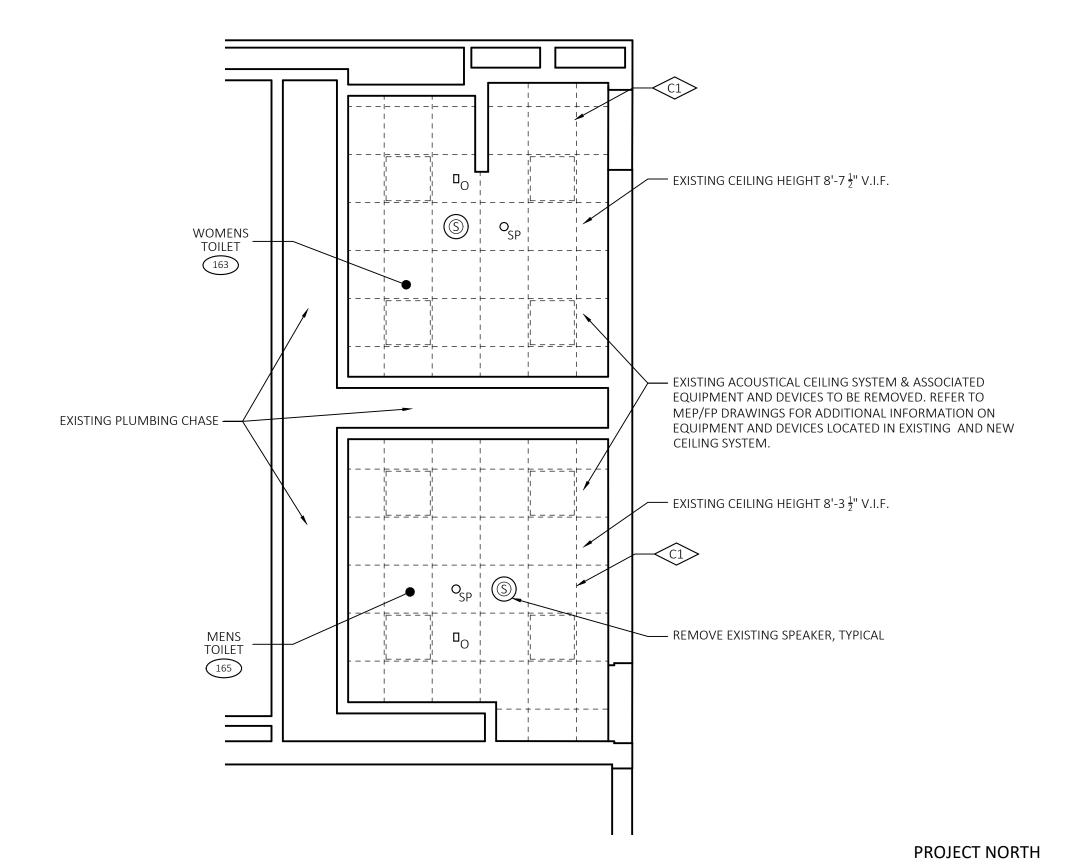

# DEMO - REFLECTED CEILING PLAN

AT ALL WORK AREAS - ALL EXISTING SUSPENDED ACOUSTICAL CEILING PANELS, GRID & LIGHTING FIXTURES SHALL BE REMOVED TO ALLOW FOR INSTALLATION OF NEW CONSTRUCTION & NEW EQUIPMENT.

THE DEMOLITION PLANS ARE DIAGRAMMATIC AND INTENDED TO SHOW THE GENERAL EXTENT OF THE WORK ONLY. THE CONTRACTOR SHALL INCLUDE ALL DEMOLITION WORK REQUIRED TO ACCOMPLISH THE INTENT OF THE PLANS AND SPECIFICATIONS.

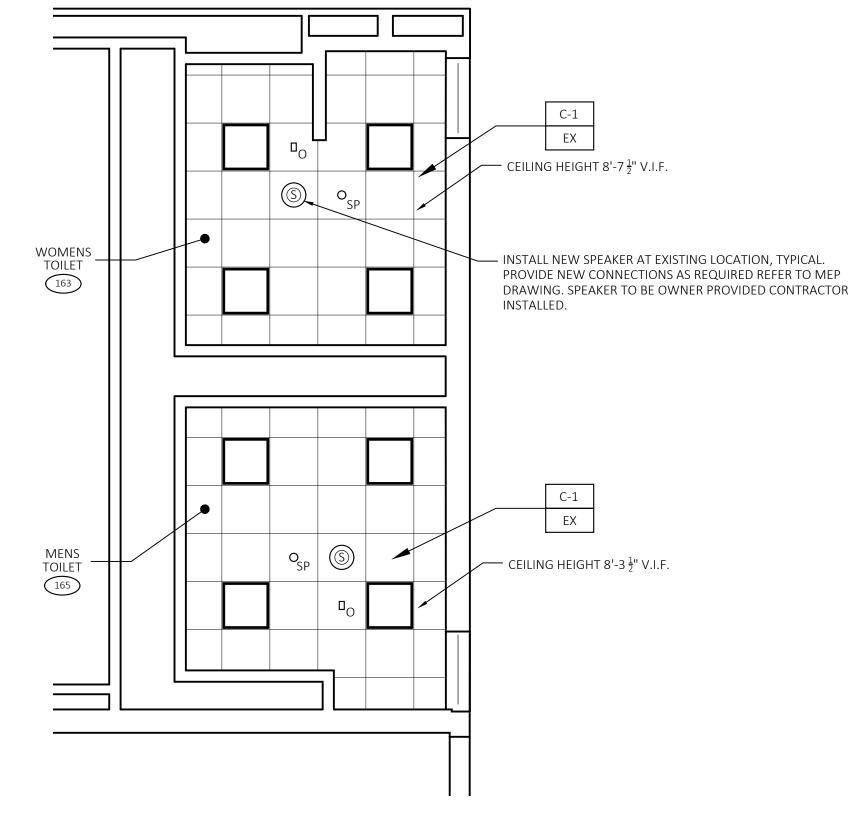


# NEW WORK - REFLECTED CEILING PLAN

INSTALL NEW OCCUPANCY SENSORS & ASSOCIATED WIRING. REFER TO ELECTRICAL DRAWINGS FOR ADDITIONAL INFORMATION.





# REFLECTED CEILING LEGEND CEILING TYPE AND HEIGHT SYMBOL -CEILING TYPE X'-X" — CEILING HEIGHT NEW RECESSED 2 X 2 LIGHT FIXTURE. REFER TO SPECIFICATIONS $oldsymbol{oldsymbol{\odot}}_{\mathsf{SP}}$ SPRINKLER HEAD SPEAKER LOCATION - REMOVE EXISTING / INSTALL NEW EMERGENCY LIGHTING TESTING OUTLET

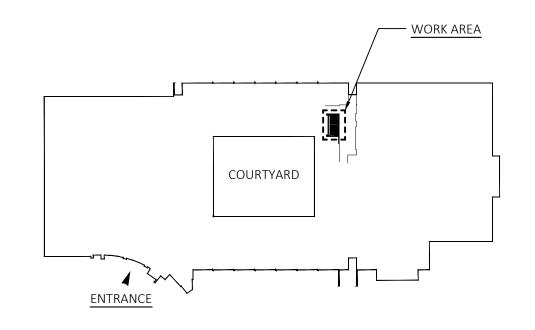


**BUILDING KEY PLAN** 



A2.1

drawing ti		EILING PLAN	CONNETICUT STATE COLLEGES AND UNIVE	RSITIES	
	RE	VISIONS	FACILITIES PLANNING		
mark	date	description	drawing prepared by:	date:	
			FRIAR ARCHITECTURE, INC.	03-14-202 scale	
			,	As indicate	
			21 TALCOTT NOTCH ROAD	production leader	
			FARMINGTON, CONNECTICUT 06032	PEH	
			project:	project manager:	
			BI-CTC-649	PEH	
			ASNUNTUCK COMMUNITY COLLEGE, ADA /	project architect:	
			OCR RESTROOM UPGRADES, PHASE 2A	RWR	
				peer reviewer:	
			170 ELM STREET ENFIELD,	drawing no	
			CONNECTICUT 06082	drawing no.	

BI-CTC-649

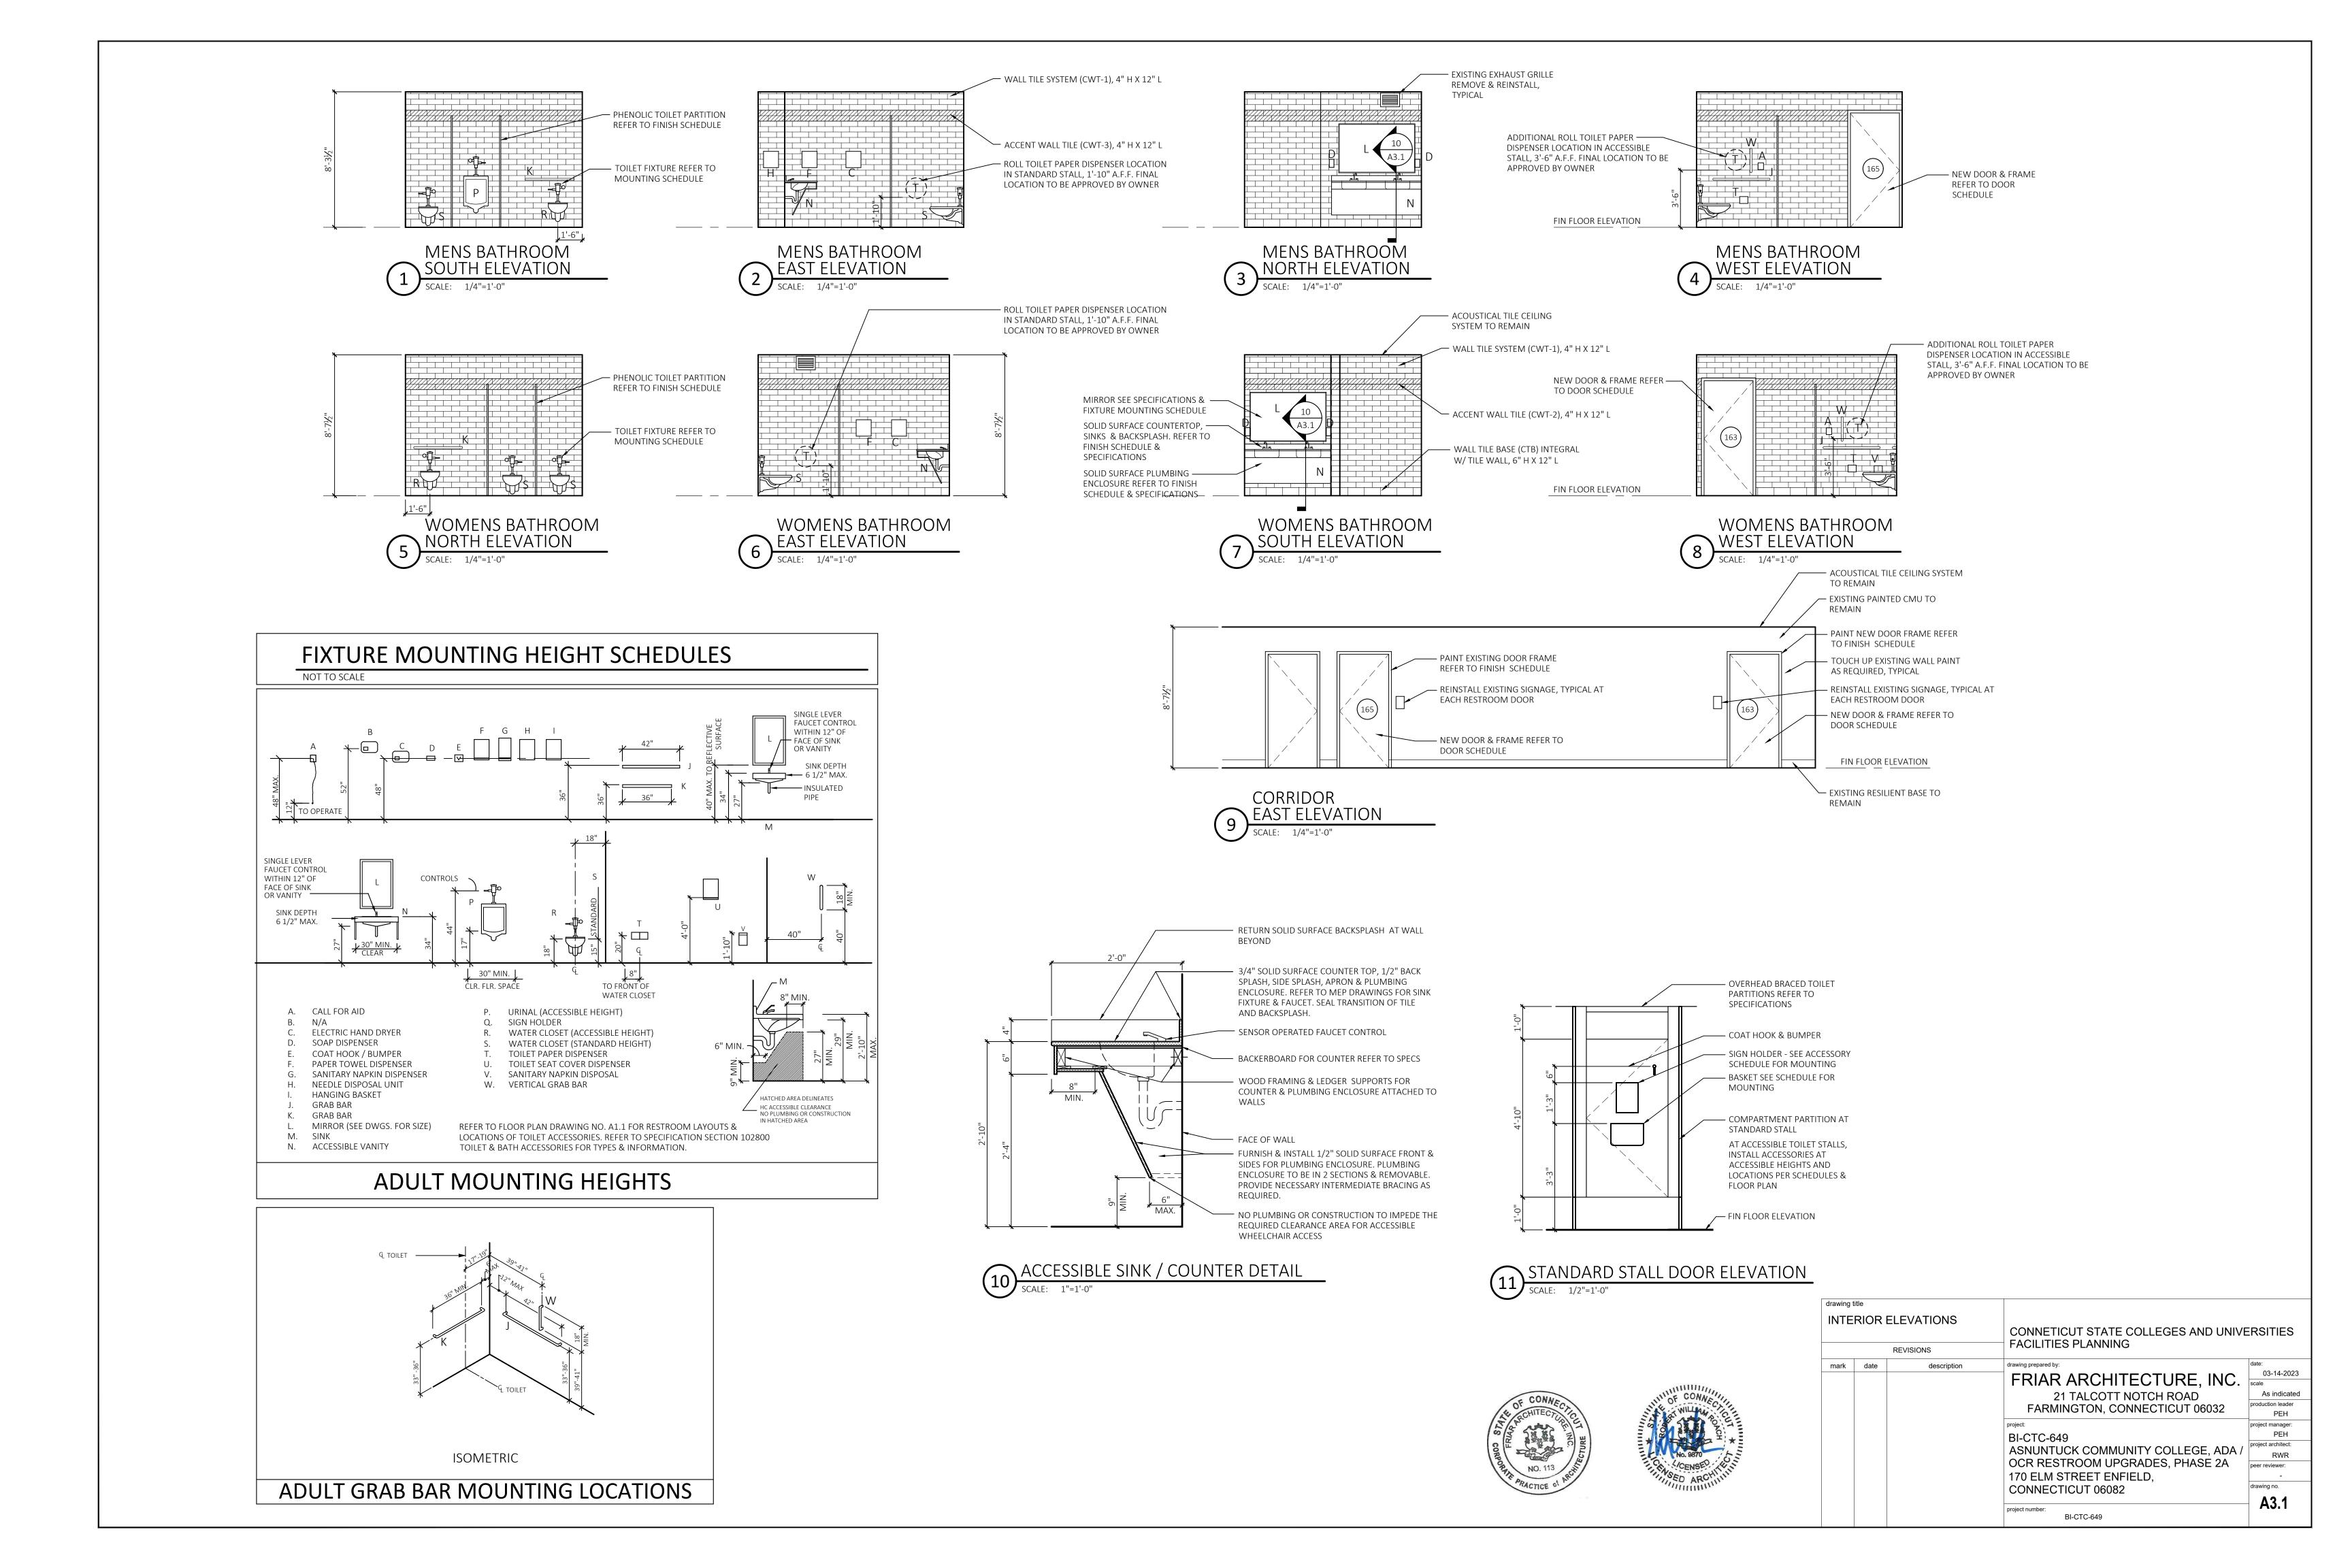

# **GENERAL REMARKS:**

- 1. ALL NEW COUNTERTOPS TO HAVE SOLID SURFACE (SS).
- 2. REFER TO DOOR SCHEDULE FOR DOOR FRAMES. FRAMES SHALL BE PRIMED AND PAINTED AS INDICATED IN SPEC SECTION 099100.

# FLOOR FINISH NOTES:

- 1. REFER TO FINISH SCHEDULE FOR COLOR DESIGNATIONS.
- 2. ALL FLOOR FINISHES TO EXTEND TO MEET WALL AND/OR BASE OF CASEWORK.
- 3. FINISH PLAN SHOULD BE USED IN CONJUNCTION WITH FINISH SCHEDULE. SHOULD THERE BE ANY DISCREPANCY BETWEEN OTHER DRAWINGS IN THE SET, THE HIGHER QUALITY FINISH SHALL BE PROVIDED.

### TILE SYSTEMS:

REFER TO TILING SPECIFICATION FOR ADDITIONAL INFO

ITEM - TILE / FLOOR UNDERLAYMENT MIX - TYPICAL AS REQUIRED AT NEW PORCELAIN TILE FLOOR. DESCRIPTION: BASIS OF DESIGN, TCC TILE CRETE TO BE USED AS A PATCHING PRODUCT AS REQUIRED AT EXISTING CONCRETE FOR LEVEL & SMOOTH SURFACE. AS TO ALLOW PORCELAIN TILE FLOOR SYSTEM INSTALLATION OVER EXISTING CONCRETE FLOOR

#### CT- WALL TILE

- MANUFACTURER: CROSSVILLE INC. RETRO ACTIVE 2.0 AND PATTERNS COLOR: EMPRESS WHITE LOCATION - TOILET ROOM BASE - SIZE 6" X 12" BASE FINISH PATTERNED (PTN)
- MANUFACTURER: CROSSVILLE INC. RETRO ACTIVE 2.0 AND PATTERNS COLOR: EMPRESS WHITE RET04 LOCATION - TOILET ROOM WALL - SIZE 4" X 12" (FIELD TILE) FINISH PATTERNED (PTN)
- MANUFACTURER: CROSSVILLE INC. RETRO ACTIVE 2.0 AND PATTERNS COLOR: PHANTOM RET09 LOCATION - TOILET ROOM WALL - SIZE 4" X 12" (WOMENS - ACCENT TILE) FINISH PATTERNED (PTN)
- MANUFACTURER: CROSSVILLE INC. RETRO ACTIVE 2.0 AND PATTERN COLOR: ROYAL NAVY RET13 LOCATION - TOILET ROOM WALL - SIZE 4" X 12" (MENS - ACCENT TILE) FINISH PATTERNED (PTN)

### PT- PORCELAIN FLOOR TILE

MANUFACTURER: CROSSVILLE INC. COLOR / PATTERN: BLUESTONE, PENNSYLVANIA BLUE, PORCELAIN STONE LOCATION - TOILET ROOM FLOOR - SIZE 12" X 12", 1/2 RUNNING BOND FINISH UNPOLISHED W/ CROSS-SHEEN (UPS)

### GT- GROUT

- MANUFACTURER: LATICRETE COLOR: #89 SMOKE GREY LOCATION - NEW TOILET ROOM FLOORS
- MANUFACTURER: LATICRETE COLOR: #90 LIGHT PEWTER LOCATION - NEW TOILET ROOM WALLS

### SS- SOLID SURFACE - COUNTER TOPS & BACKSPLAH

MANUFACTURER: CORIAN COLOR: ARCHEOLOGIC LOCATION - NEW TOILET ROOM COUNTERS

#### **ABBREVIATIONS** ACT - ACOUSTICAL TILE CEILING HC - ACCESSIBLE - CERAMIC FLOOR TILE CTB - WALL TILE BASE PT - PORCELAIN FLOOR TILE CTR - COUNTER R/R - REMOVE & REINSTALL CWT - WALL TILE RB - RESILIENT BASE EP - EPOXY PAINT SS - SOLID SURFACE EX-EP - EXISTING EPOXY T - THRESHOLD / CURB EX-T - EXISTING TERRAZZO FLOOR TF - TERRAZZO FLOORING GB - GRAB BAR TP - TOILET PARTITIONS - GROUT VB - VINYL BASE

#### **EP- EPOXY PAINT**

MANUFACTURER; SHERWIN WILLIAMS COLOR #SW - MODERATE WHITE SW 6140 EGGSHELL LOCATION - TOILET ROOM DOOR FRAMES (TOILET & CORRIDOR SIDES)


#### TP- TOILET PARTITIONS

TP MANUFACTURER; ASI GLOBAL PARTITIONS FLOOR ANCHORED OVERHEAD BRACED PHENOLIC COLOR THRU PANELS MENS ROOM COLOR: NAVY BLUE 7450C WOMENS ROOM COLOR: FOG 3450C REFER TO FLOOR PLAN FOR SIZES / QUANTITY LOCATION - TOILET ROOM - TOILET & URINAL ENCLOSURES

#### FP- TEMPORARY FLOOR & WALL PROTECTION

FP MANUFACTURER; RAM BOARD MODEL # S-21372 SIZE: 38" X 100' ROLLS PRESSURE SENSITIVE KRAFT TAPE LOCATION - CORRIDOR FLOOR AND WALL ADJACENT TO OPENINGS AS REQUIRED FOR PROTECTION


					FI	NISH SO	CHEDUI	LE									
	FLOOR BASE WALL MISCELLANEOUS																
ROOM NUMBER AREA DESIGNATION	ROOM OR AREA NAME			NORTH	SOUTH	EAST	WEST	COUNTER / BACKSPLASH	TOILET ROOM PARTITIONS	METAL DOOR FRAMES	PLUMBING ENCLOSURE	WALL DIFFUSERS / ACCESS DOORS	GRAB BARS	CEILING TILE (REF CEILING PLAN)	CEILING GRID (REF CEILING PLAN)		REMARKS
163	WOMENS TOILET	PT-1	CTB-1	CWT-1, 2	CWT-1, 2	CWT-1, 2	CWT-1, 2	SS-1	TP	EP-1	SS-1	EX	GB	A-1	A-1		
165	MENS TOILET	PT-1	CTB-1	CWT-1, 2	CWT-1, 3	CWT-1, 3	CWT-1, 3	SS-1	TP		SS-1	EX	GB	A-1	A-1		
247	CORRIDOR	TF-EX	RB-EX	-	-	-	-			EP-1							
247	CORRIDOR	FP														FLOOR P	PROTECTION - AS REQ'D

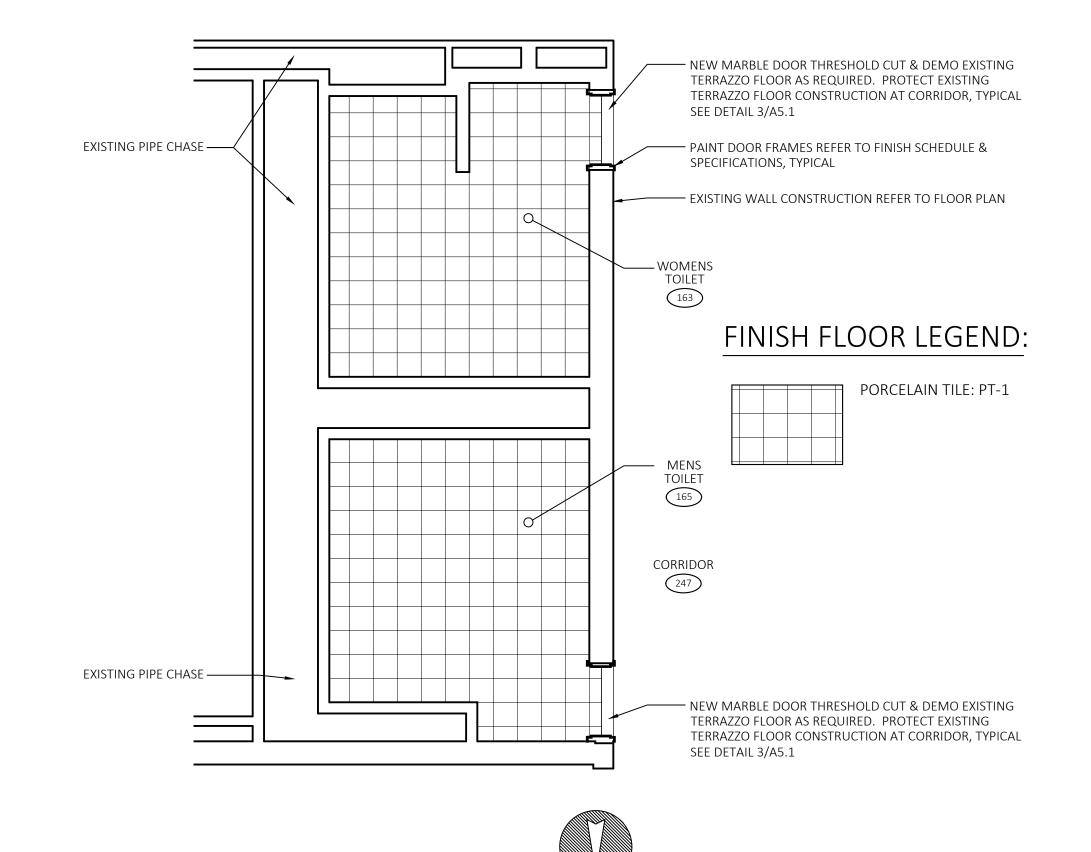

PROJECT


### TYPICAL NEW CERAMIC TILE WALL FINISH SYSTEMS

INSTALL WALL TILE SYSTEM TYPICAL. REFER TO FINISH SCHEDULE

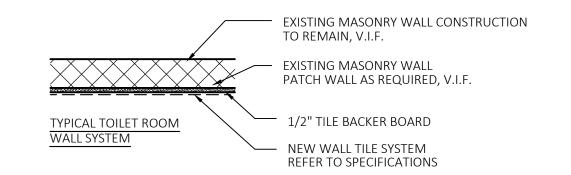

# **FINISH NOTES:**

- 1. CONTRACTOR SHALL PATCH AND REPAIR EXISTING SURFACES WHERE NECESSARY TO CREATE A SMOOTH AND CONTINUOUS SURFACE PRIOR TO INSTALLING NEW FINISHES AND PRIOR TO PAINTING EXISTING SURFACES.
- 2. CAULK ALL JOINTS BETWEEN CEILING SURFACES & WALL SURFACES.
- 3. EXISTING FLOOR COVERING SHALL BE REMOVED TO ALLOW FOR NEW CONSTRUCTION. CONTRACTOR SHALL PROTECT EXISTING FINISHES TO REMAIN FROM DAMAGE DURING PROJECT. FLOORS ARE TO BE PREPARED TO ACCEPT NEW MATERIALS AS INDICATED ON PLAN.
- 4. THE CONTRACTOR SHALL BE RESPONSIBLE FOR VENTILATING THE AREA IN WHICH CONSTRUCTION IS TAKING PLACE TO REMOVE CONTAMINANTS PRODUCED BY OUT-GASSING OF NEW MATERIALS, THE USE OF ADHESIVES AND SOLVENTS, AND ALL OTHER CONSTRUCTION ACTIVITIES. VENTILATION OF THE SPACE SHALL BE ACCOMPLISHED WITHOUT ALLOWING AIR EXHAUSTED FROM THE CONSTRUCTION AREA TO INFILTRATE ANY OTHER PORTION OF THE FLOOR OR BUILDING. THE METHOD TO BE EMPLOYED SHALL BE APPROVED BY OWNER'S REPRESENTATIVE BEFORE IMPLEMENTATION.
- 5. THE CONTRACTOR SHALL ONLY USE ADHESIVE THAT IS ENVIRONMENTALLY SAFE AND CONTAINS NO SOLVENTS, ALCOHOL, GLYCOL, AMMONIA OR CARCINOGENS AND MUST BE A LOW V.O.C.
- 6. ALL EXPOSED MECHANICAL, ELECTRICAL, PLUMBING AND FIRE PROTECTION EQUIPMENT WITHIN THE SCOPE OF WORK AREAS ARE TO RECEIVE A PAINT FINISH. REFER TO SPECIFICATION SECTION 099123 - INTERIOR PAINTING FOR PAINT SYSTEM. PAINT COLOR TO MATCH NEW ADJACENT WALL OR CEILING FINISH.

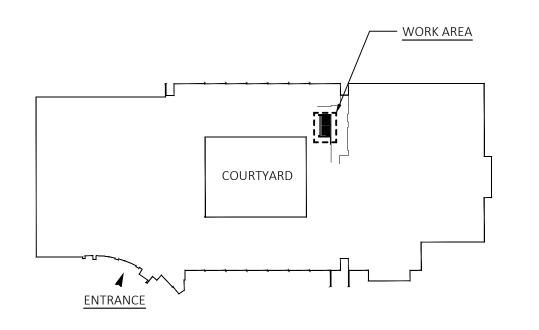

# **BUILDING KEY PLAN**



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			REVISIONS	FACILITIES PL
	mark	date	description	drawing prepared by:
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TAILS		CONNETICUT STATE COLLEGES AND UNIVERSITIES						
	REVISIONS	FACILITIES PLANNING						
date	description	drawing prepared by:	date:					
	·	EDIAD ADCHITECTURE INC	03-14-2023					
			scale					
		21 TALCOTT NOTCH ROAD	As indicated					
		EARMINGTON CONNECTICUT 06032	production leader					
		TARMINGTON, CONNECTION 100032	PEH					
		project:	project manager:					
		BI-CTC-649	PEH					
			project architect:					
		,	RWR					
		OCR RESTROOM UPGRADES, PHASE 2A	peer reviewer:					
		170 ELM STREET ENFIELD.	-					
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		0011112011001 00002	A A A					
		project number:	<b>→ A4.1</b>					
		BI-CTC-649						
	SH PLA	SH PLAN, SCHEDULE, TAILS REVISIONS	CONNETICUT STATE COLLEGES AND UNIVER FACILITIES PLANNING    date   description     TRIAR ARCHITECTURE, INC. 21 TALCOTT NOTCH ROAD FARMINGTON, CONNECTICUT 06032     project: BI-CTC-649     ASNUNTUCK COMMUNITY COLLEGE, ADA / OCR RESTROOM UPGRADES, PHASE 2A 170 ELM STREET ENFIELD, CONNECTICUT 06082     project number:					



		SPRINKLERED	)	NONSPRINKLERED					
GROUP	VERTICAL EXITS & EXIT PASSAGEWAYS	EXIT ACCESS CORRIDORS & OTHER EXITWAYS	ROOMS AND ENCLOSED SPACES	VERTICAL EXITS & EXIT PASSAGEWAYS	EXIT ACCESS CORRIDORS & OTHER EXITWAYS	ROOMS AND ENCLOSED SPACES			
A-1 & A-2	В	В	С	А	А	В			
A-3, A-4, A-5	В	В	С	А	А	С			
B, E, M	В	С	С	А	В	С			

INTERIOR WALLS AND CEILING FINISHES SHALL BE CLASSIFIED IN ACCORDANCE WITH ASTM E 84.

FINISH FLOOR PLAN






										DOO	R SCI	HEC	DU	LE						
	DESCRIPTION OF WORK			DOOR			FRAME					HARDWARE- SEE SPECIFICATIONS			SIGN	SIGNAGE TEXT				
DOOR NUMBER	NEW DOOR & FRAME NEW DOOR / EXISTING FRAME			DOOR WIDTH	DOOR HEIGHT	MATERIAL/TYPE	ТҮРЕ	HEAD DETAIL	JAMB DETAIL	FIRE RATING	THRESHOLD DETAIL	EADBOLT		90 DEGREE OPENING LIMIT	DOOR PULL / PUSH PLATE  YICK PLATES / MOP PLATES	R SILENCERS	H.C. ACCESSIBLE THRESHOLD	60" O	ΓΙΝG HEIGHT: .C. ABOVE Η FLOOR	O INDICATES EXISTING CONDITION  ● INDICATES REQUIRED WORK  ● REUSE EXISTING - REMOVE FROM EXISTING AND INSTALL ON NEW  REMARKS
163				3'-0"	7'-0"	WD-1	HM-1	1	2	-	3		•		• •		lacktriangle	WOMENS	TOILET	<u> </u>
	•			3'-0"	7'-0"	WD-1	HM-1	1	2	-	3		•		•			MENS TOI	LET	

# DOOR SCHEDULE / PRODUCT INFO:

BASIS OF DESIGN INFORMATION -

REFER TO SPECIFICATION SECTION 087100 DOOR HARDWARE FOR BALANCE OF HARDWARE

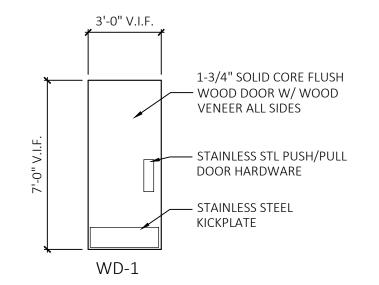


TYPICAL INTERIOR WOOD DOOR - BATHROOM DOORS (SWL-1): 36" X 84" SOLID CORE DOOR W/ WOOD VENEER FACES. VERIFY IN FIELD ALL EXISTING DIMENSIONS & COORDINATE INSTALLATION PRIOR TO ORDERING DOORS & HARDWARE.

DOOR BASIS OF DESIGN: VT INDUSTRIES ARCHITECTURAL WOOD DOORS - EXTRA HEAVY DUTY PARTICLE CORE, NON RATED & 20 MIN. SPECIES: SELECT WHITE MAPLE COLOR: GRASSLAND, GR18

# DOOR TYPES

# **HOLLOW METAL FRAMES**

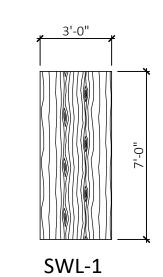


# DOOR / HARDWARE NOTES


DOOR HARDWARE SUPPLIER/MANUFACTURER MUST PROVIDE SUFFICIENT REINFORCING FOR ALL DOOR HARDWARE.

INSTALLERS WILL MAKE ANY FINAL ADJUSTMENTS TO ASSURE THE SMOOTH OPERATION OF THE DOOR & DOOR HARDWARE

CONTRACTOR TO COORDINATE DOOR HARDWARE/ LOCKSMITH CONTRACTOR TO UPDATE EXISTING DOOR HARDWARE FOR OWNER AS REQUIRED

ALL DOORS IN MASONRY WALLS TO BE UNDERCUT ¾" VERIFY IN FIELD BEFORE ORDERING DOORS

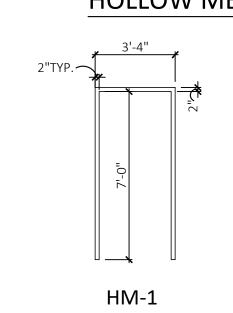

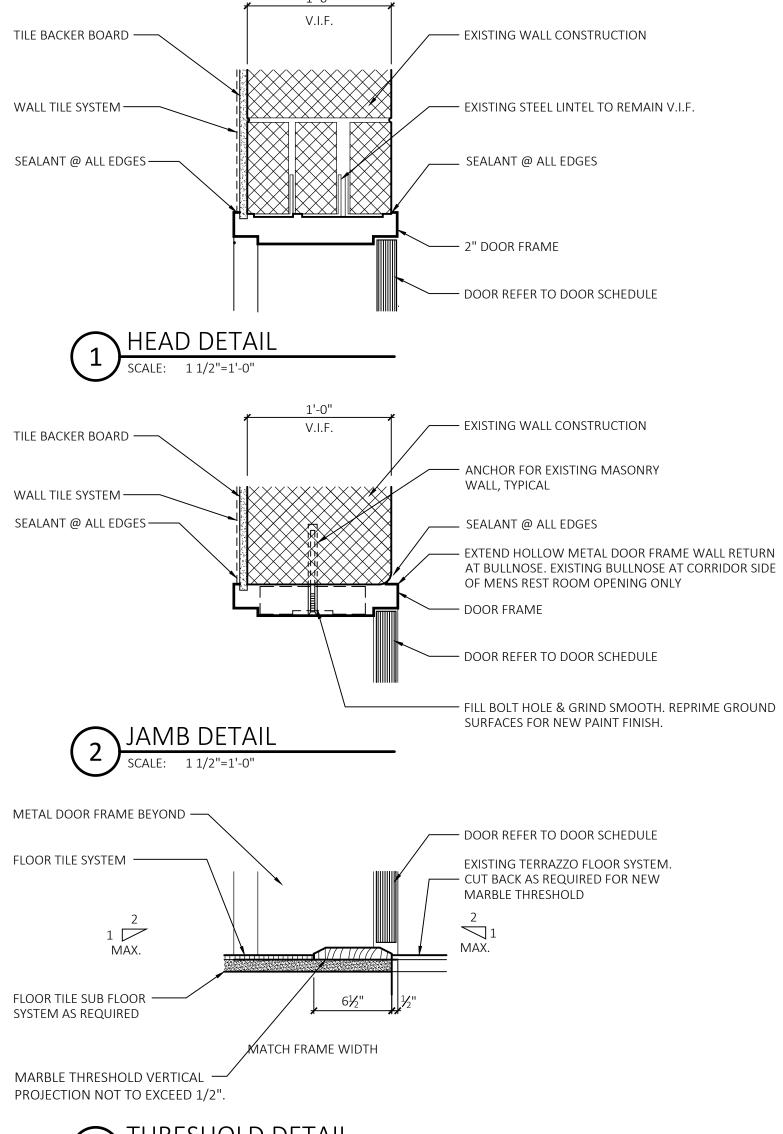








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	RE	VISIONS	FACILITIES PLANNING							
mark	date	description	FRIAR ARCHITECTURE, INC.	date: 03-14-2023 scale						
			21 TALCOTT NOTCH ROAD FARMINGTON, CONNECTICUT 06032	As indicated production leader PEH						
			BI-CTC-649 ASNUNTUCK COMMUNITY COLLEGE, ADA /	project manager: PEH project architect: RWR						
			OCR RESTROOM UPGRADES, PHASE 2A 170 ELM STREET ENFIELD, CONNECTICUT 06082	peer reviewer: - drawing no.						
			project number: BI-CTC-649	A5.1						




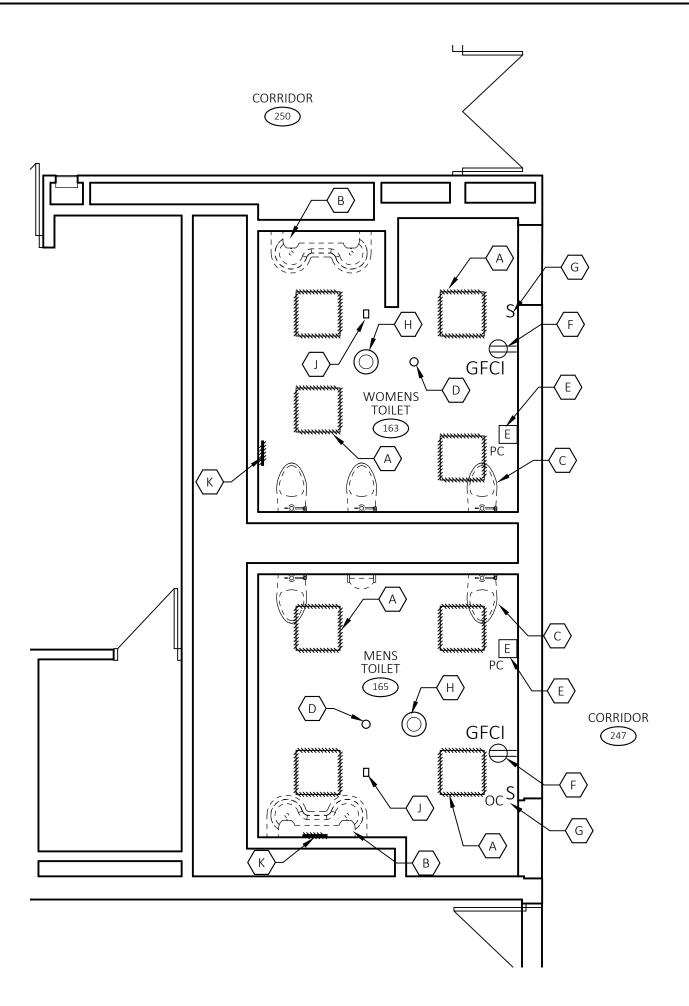

NEW WORK - ELECTRICAL FLOOR PLAN

SCALE: 1/4"=1'-0"

# DEMO - FLOOR PLAN

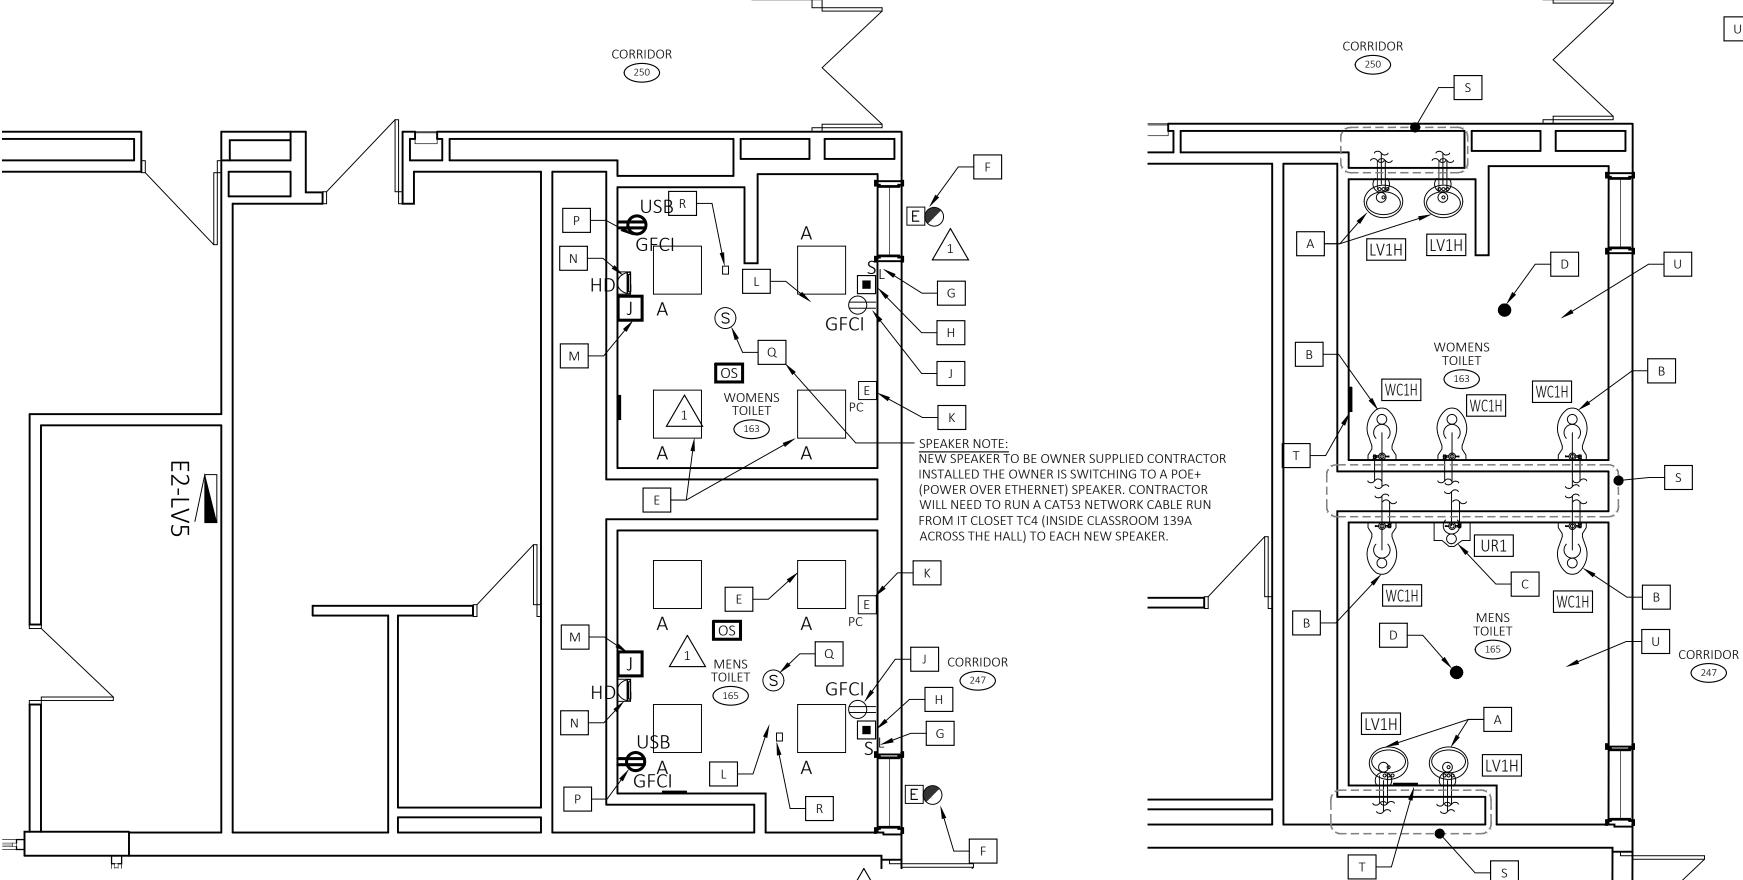

PROJECT NORTH

# DEMOLITION CALLOUT NOTES NEW \

- REMOVE AND RETAIN EXISTING 2' X 2' LIGHT FIXTURES FOR TURN-OVER TO OWNER. RETAIN EXISTING WIRING FOR INSTALLATION OF NEW 2' X 2' FIXTURES AND DEVICES.
- B REMOVE AND RETAIN EXISTING "BRADLEY TYPE SINK FOR TURN-OVER TO OWNER. RETAIN AND PROTECT ALL PIPING FOR INSTALLATION OF NEW LAVATORIES.
- C REMOVE AND RETAIN EXISTING WATER CLOSETS AND URINAL FOR TURN-OVER TO OWNER. RETAIN AND PROTECT ALL PIPING FOR INSTALLATION OF NEW WATER CLOSETS AND URINAL.
- REMOVE EXISTING PENDENT SPRINKLER HEADS. PREP FOR INSTALLATION OF NEW CONCEALED SPRINKLER HEADS
- REMOVE, RETAIN AND PROTECT EXISTING CALL FOR AID PULL STATION FOR RE-INSTALLATION UPON COMPLETION OF FINISHES.
- RECEPTACLE FOR RE-INSTALLATION UPON COMPLETION OF FINISHES.

  G REMOVE EXISTING SWITCH, RETAIN WIRING FOR

F REMOVE, RETAIN AND PROTECT EXISTING DUPLEX

- INSTALLATION OF NEW SWITCH.

  H REMOVE EXISTING SPEAKER FOR INSTALLATION OF NEW SPEAKER IN NEW CEILING TILES. RETAIN EXISTING
- $\langle I \rangle$  NOT IN USE.
- REMOVE, RETAIN AND PROTECT EXISTING TEST DEVICE FOR RE-INSTALLATION IN NEW CEILING TILES. RETAIN EXISTING WIRING.
- K REMOVE, RETAIN AND PROTECT EXISTING EXHAUST

NEW WORK - M/P/FP FLOOR PLAN

# **NEW WORK CALLOUT NOTES**

A FURNISH AND INSTALL NEW UNDERCOUNTER LAVATORIES. (SEE SCHEDULE) TYP. X 4

B FURNISH AND INSTALL NEW WATER CLOSETS.

- INSTALLATION AS PER ANSI A117.1, 2017. (SEE SCHEDULE) TYP. X 5
- C FURNISH AND INSTALL NEW URINAL. (SEE SCHEDULE)
- D FURNISH AND INSTALL NEW CONCEALED SPRINKLER HEAD WITH WHITE COVER PLATE.
- E FURNISH AND INSTALL NEW 2' X 2' LED LIGHT FIXTURES. TIE INTO EXISTING WIRING. ( SEE SCHEDULE)
- F EXISTING VISUAL CALL FOR AID DEVICE TO REMAIN.
- G FURNISH AND INSTALL NEW SWITCH. (SEE ELECTRICAL LEGEND)
- H FURNISH AND INSTALL NEW FIRE ALARM STROBE, COMPATIBLE WITH EXISTING FIRE ALARM SYSTEM.
- I NOT IN USE.
- J REINSTALL GFCI RECEPTACLE.
- K REINSTALL EXISTING CALL FOR AID PULL STATION IN ORIGINAL LOCATION.
- L FURNISH AND INSTALL NEW CEILING MOUNTED OCCUPANCY SENSOR. WIRE TO NEW FIXTURES.
- M FURNISH AND INSTALL NEW POWER SOURCE AND JUNCTION BOX FROM PANEL E2-LV5.
  SUPPLY NEW 20AMP CIRCUIT BREAKER FOR ELECTRIC HAND DRYER.
- N FURNISH AND INSTALL NEW ELECTRIC HAND DRYER. (SEE SCHEDULE)
- O NOT IN USE.
- P FURNISH AND INSTALL NEW DUAL
  RECEPTACLE/USB ASSEMBLY, RECESSED IN
  WALL AND MOUNTED 8" ABOVE COUNTER TOP.
  (SEE ELECTRICAL LEGEND)
- Q INSTALL NEW SPEAKER, FURNISH AND INSTALL ADDITIONAL WIRING/FITTINGS AS NECESSARY.
- R REINSTALL EXISTING TEST DEVICE.
- RECONNECT ALL PLUMBING FIXTURES TO EXISTING HOT WATER, COLD WATER AND SANITARY PIPING. SUPPLY ALL NECESSARY PIPE, VALVES AND FITTINGS NECESSARY FOR PROPER RE-CONNECTION. INSULATE AS REQUIRED.
- T REPLACE EXISTING GRILLES UPON COMPLETION OF TILE INSTALLATION. TOUCH-UP PAINT AS NECESSARY. BALANCE EXISTING EXHAUST REGISTERS TO 130 CFM.
- SMOKE DETECTORS TO BE OWNER SUPPLIED CONTRACTOR INSTALLED TO MATCH OWNERS STANDARD FIXTURE. ELECTRICALLY WIRED SMOKE DETECTORS WITH BATTERY BACK UP. FINAL LOCATION TO BE DETERMINED BY OWNER, TYPICAL FOR EACH TOILET ROOM.

ELECTRICAL NOTE:
ALL SURFACE MOUNTED DEVICES TO BE
SUPPLIED BY WIRING RUN WITHIN SURFACE
MOUNTED RACEWAY. PROVIDE AND INSTALL
RACEWAY, BOXES, FITTINGS AND HANGERS.
POWER SOURCE CONNECTION FROM PANEL


# PLUMBING FIXTURE SCHEDULE

### PLUMBING FIXTURE NOTES:

- THE PLUMBING SUBMITTALS SHALL HAVE ALL EQUIPMENT/FIXTURES AND ASSOCIATED TRIM IDENTIFIED AS INDICATED BELOW FOR APPROVAL. ALL FIXTURES AND EQUIPMENT SHALL BE AS SPECIFIED OR EQUAL.
- THE PLUMBING CONTRACTOR SHALL PROVIDE AND INSTALL ALL NECESSARY TRIM (ADAPTERS, SUPPLIES, STOPS, TRAPS, FITTINGS, CONNECTORS, COUPLING, ETC.) TO MAKE FINAL CONNECTION AND INSTALL A COMPLETE SYSTEM.
- 3. ALL HANDICAP FIXTURES SHALL BE INSTALLED PER ANSI A117.1, 2017.
- REFER TO THE ARCHITECTURAL DRAWINGS FOR FIXTURE MOUNTING HEIGHTS AND EXACT LOCATIONS.


TYPE	FIXTURE	SOIL/ VENT		HOT WATER	COLD WATER	MOUNTING	DESCRIPTION				
WC1H	WATER CLOSET	4"	2"	-	1/,"	WALL	AMERICAN STANDARD, " AFWALL MILLENNIUM" FLUSHOMETER TOILET, MODEL # 2257.101, ELONGATED, TOP SPUD, WHITE, VITREOUS CHINA WITH DC POWER MODEL # 121.002 SENSOR OPERATED, 1.28 GPF FLUSHOMETER AND MODEL # 5901.100 OPEN FRONT WHITE SEAT.				
UR1	URINAL	2"	1½"	1	½"	WALL	AMERICAN STANDARD, "WASHBROOK" FLOWISE 0.5 GPF HIGH EFFICIENCY URINAL, MODEL # 6590.001, W/ 0.5 GPF TOP SPUD AND DC POWER SELECTRONIC SENSOR OPERATED FLUSH VALVE, MODEL #6063.051.002, WHITE VITREOUS CHINA.				
LV1H	LAVATORY	1½"	1½"	<del>½</del> "	½"	UNDER COUNTER	AMERICAN STANDARD "OVALYN" UNIVERSAL ACCESS UNDERCOUNTER, MODEL # 9482.000, WHITE, VITREOUS CHINA, SELECTRONIC ELECTRONIC PROXIMITY FAUCET, MODEL # 6055.104, 4" DECK PLATE MODEL # 605P.400 AND OPTIONAL MIXING VALVE, MODEL # 605XTMV1070 COMPLETE WITH FLEXIBLE HOSES AND COMPRESSION FITTINGS. FURNISH WITH TRUEBRO LAV GUARD 2E-Z SERIES COVERS.				

LIGHTING/EQUIPMENT FIXTURE SCHEDULE											
TYPE	SYMBOL	DESCRIPTION	VOLTS	MOUNTING	LAMP						
					TYPE	WATTS					
А		2' x 2' LED RECESSED TROFFER, WHITE FINISH, FROSTED ACRYLIC LENS, LED DRIVER. COLUMBIA LIGHTING MODEL # LJT22-35MLG-FSA12125F-EU.	120	RECESSED	LED	35					
HD		XLERATOR HAND DRYER, MODEL # XL-SB, BRUSHED STAINLESS STEEL. 8 SECOND DRY TIME, 39 - 64 CFM	120	SURFACE	-	-					

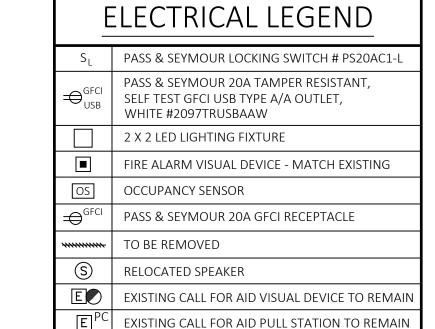

PEH

**MEP1.1** 

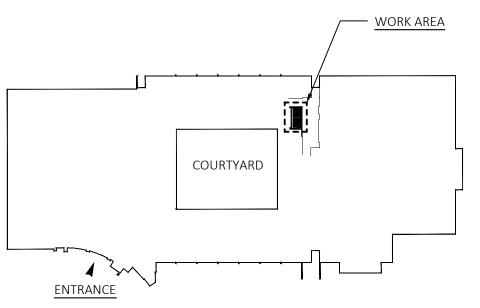



drawing title
MEP FLOOR PLAN /
DEMOLITION PLAN

REVISIONS

mark date description

CONNETICUT STATE COLLEGES AND UNIVERSITIES FACILITIES PLANNING

drawing prepared by:
FRIAR ARCHITECTURE, INC.

21 TALCOTT NOTCH ROAD
FARMINGTON, CONNECTICUT 06032

date:
03-14-2023
scale
As indicate:
production leader
PEH

BI-CTC-649

ASNUNTUCK COMMUNITY COLLEGE, ADA /

OCR RESTROOM UPGRADES, PHASE 2A

170 ELM STREET ENFIELD.

**CONNECTICUT 06082** 

