# STATE OF CONNECTICUT



# GOVERNOR NED LAMONT

DEPARTMENT OF ADMINISTRATIVE SERVICES
MICHELLE HALLORAN GILMAN
COMMISSIONER

CONNECTICUT STATE COLLEGES AND UNIVERSITIES
TERRENCE CHENG
PRESIDENT

ASNUNTUCK COMMUNITY COLLEGE
ADA/OCR RESTROOM UPGRADES, PHASE 2
170 ELM STREET
ENFIELD, CT 06082

PROJECT NO. BI-CTC-649

ARCHITECT FRIAR ARCHITECTURE, INC. 21 TALCOTT NOTCH ROAD FARMINGTON, CT 06032 (860)-678-1291 CONTRACT DRAWINGS

NO. TITLE COVER SHEET

ARCHITECTURAL DRAWINGS

1.1 REFERENCE SHEET / CODE INFORMATION
1.2 CODE INFORMATION

A2.1 REFLECTED CEILING PLA
A3.1 INTERIOR FLEVATIONS

A4.1 FINISH PLAN, SCHEDULE & DETAILS


A5.1 DOOR SCHEDULE & DETAILS

MECHANICAL / ELECTRICAL / PLUMBING DRAWINGS


MEP1.1 (MECHANICAL / ELECTRICAL / PLUMBING) MEP FLOOR PLAN &

DEMOLITION PLA

D.C.S BUILDING NUMBER 00000

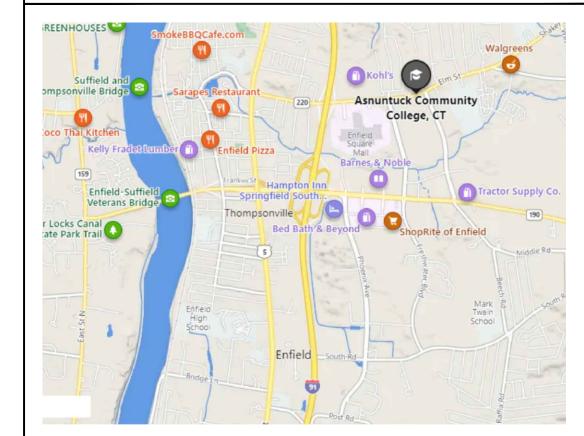

SITE PLAN

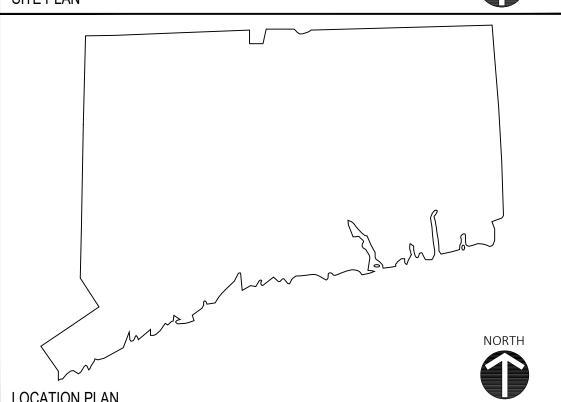


### **ABBREVIATIONS**

### **ABBREVIATIONS**

ABOVE FINISH FLOOR	A.F.F.	JOINT	JT.
ACOUSTIC TILE	A.C.T.	LAVATORY	LAV.
ALTERNATE	ALT.	LIGHTING	LTG.
ANGLE	L		210.
ARCHITECTURAL/ARCHITECT		MANUFACTURER	MFR.
AT	@	MASONRY	MAS.
BOARD	BD.	MASONRY OPENING	M.O.
BOTTOM OF	B/O	MATERIAL	MATL.
BUILDING	BLDG.	MAXIMUM	MAX.
		MECHANICAL	MECH.
CEILING	CLG.	MINIMUM	MIN.
CENTER	CTR.	MISCELLANEOUS	MISC.
CERAMIC FLOOR TILE CERAMIC TILE BASE	CT CTB	ON CENTER	O.C.
CERAMIC WALL TILE	CWT		
CONTROL OR	CVVI	PAINT	Р
CONSTRUCTION JOINT	C.J.	PAINTED	PTD.
CONTINUOUS	CONT.	PLASTIC LAMINATE	P.LAM.
CORRIDOR	CORR.	PLYWOOD	PLYWD
		PREFABRICATED	PREFAE
DEMOLITION	DEMO.	POINT	PT.
DIMENSION	DIM.	1 31141	
DOWN	DN.	RADIUS	RAD.
		REINFORCED / REINFORCING	REINF.
ELECTRIC / ELECTRICAL	ELEC.	REQUIRED	REQ'D.
ELEVATION	EL.	REVISION, REVISED	REV.
ELEVATOR	ELEV.	ROOM	RM.
EQUAL	EQ.		
EXISTING	EXIST.	SCHEDULE	SCHED.
EXPANSION JOINT	E.J.	SECTION	SECT.
EXPANSION	EXP.	SHEET	SHT.
EXPANSION JOINT	E.J.	SIMILAR	SIM.
FEET, FOOT	FT.	SPECIFICATIONS	SPEC.
FINISH, FINISHED	FIN.	SQUARE FEET (FOOT)	S.F.
FIXTURE	FIXT.	STAINLESS STEEL	ST. STL
FLOOR	FL.	STANDARD STEEL	STD.
FLOOR DRAIN	FD.	STORAGE	STL. STOR.
CVDCLINA DO A DO	CVD DD	STRUCTURAL	STRUC
GYPSUM BOARD	GYP.BD.	SOLID SURFACE	SS
HANDICAPPED	H.C.	SUSPEND, SUSPENSION	SUSP.
HEIGHT	HGT.	SYSTEM	SYS.
HOLLOW METAL	HM.	STOTEIVI	515.
HORIZONTAL	HORIZ.		
INCH OR INCHES	IN. OR "	TO BE DETERMINED	TBD
INFORMATION	INFO.	TEMPERATURE/TEMPORARY	TEMP.
INSULATION	INSUL.	TOP OF	T/O
INTERIOR	INT.	TYPICAL	TYP.
		UNDERWRITER'S LABORATORIES	U.L.
		VERIFY IN FIELD	V.I.F.
		VERTICAL	V.I.F. VERT.
		VINYL ASBESTOS TILE	V.A.T.
		VINYL COMPOSITION TILE	V.C.T.

### F Rating - 3 Hr T Ratings - 0, 2 & 3 Hr (See Item 2)

WATER CLOSET

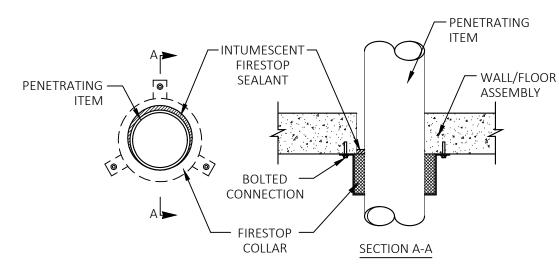


UL RATED DETAILS

W.C.

### SYMBOLS LEGEND


### ARCHITECTURAL SYMBOLS

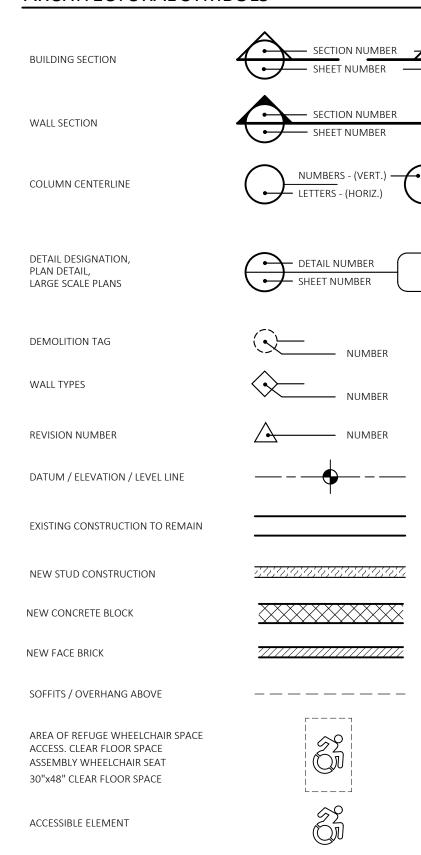

### ARCHITECTURAL MATERIALS

C.M.U.		PLYWOOD	
CONCRETE	4	RIGID INSULATION	
FACE BRICK		ROUGH WOOD (CONTINUOUS)	
FACE GRAIN		ROUGH WOOD (INTERRUPTED)	
FINISHED WOOD		BATT INSULATION	
GYPSUM BOARD		PLASTER	
ACOUSTICAL TILE		SHEATHING INSUL.	
ALUMINUM		STEEL	
CAST STONE		ROOF BALLAST	+ + + + + + + + + + + + + + + + + + + +

F-RATING = 3 HR. T-RATING = 0 HR.
L-RATING AT AMBIENT = LESS THAN 1 CFM/SG. FT.
L-RATING AT 400° F = 4CFM/SQ. FT.

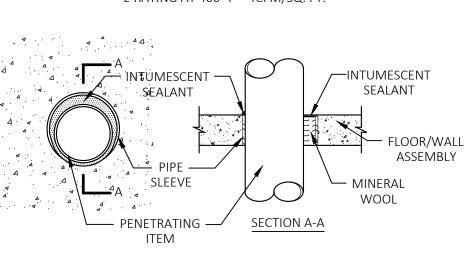

### **NOTES**

### CONSTRUCTION NOTES

- 1. ALL WORK SHALL BE PERFORMED IN STRICT ACCORDANCE WITH ALL NATIONAL, STATE AND LOCAL CODES AND ORDINANCES.
- 2. DO NOT SCALE DRAWINGS. THE CONTRACTOR SHALL BE RESPONSIBLE FOR OBTAINING CLARIFICATION OF DIMENSIONS FROM THE ARCHITECT BEFORE CONTINUING WITH CONSTRUCTION.
- 3. CONTRACT DRAWINGS MAY VARY FROM ACTUAL FIELD CONDITIONS. CONTRACTOR SHALL CORRECT DIMENSIONS OF ALL MATERIALS TO CARRY OUT THE INTENT OF THE CONTRACT DRAWINGS. VERIFY ALL DIMENSIONS AND EXISTING CONDITIONS IN FIELD BEFORE ORDERING ANY MATERIALS. CONTRACTOR SHALL NOTIFY ARCHITECT PROMPTLY OF ANY CRITICAL DISCREPANCIES BEFORE PROCEEDING WITH WORK.
- 4. ALL NEW WORK SHALL BE IMPLEMENTED SO AS TO PROVIDE A SMOOTH AND CONTINUOUS SURFACE WITH ALL EXISTING CONDITIONS. CONTRACTOR SHALL BE RESPONSIBLE FOR ALL WORK NECESSARY TO ACHIEVE THIS REQUIREMENT, EVEN THOUGH PROCEDURES ARE NOT DETAILED FOR EACH SPECIFIC CONDITION OR COMBINATION OF CONDITIONS. QUALITY OF WORKMANSHIP, MATERIALS AND FINISHES SHALL BE EQUAL TO THE LEVEL ESTABLISHED FOR SIMILAR CONSTRUCTION, EXCEPT WHERE EXISTING APPEARANCE IS TO BE MATCHED TO ACHIEVE CONTINUITY.
- 5. CUTTING AND PATCHING SHALL BE THE RESPONSIBILITY OF THE TRADE WHOSE WORK RESULTS IN THE NEED FOR CUTTING AND PATCHING UNLESS A SPECIFIC CONTRACTOR IS CALLED OUT ON THE DRAWINGS. ALL HOLES LEFT BY REMOVING MECHANICAL, PLUMBING AND ELECTRICAL EQUIPMENT, ETC. SHALL BE PATCHED.
- 6. UNLESS OTHERWISE NOTED OR DIMENSIONED, NEW PARTITIONS SHALL BE CENTERED ON BUILDING COLUMN GRID OR WINDOW MULLIONS.
- 7. CONTRACTOR SHALL PROVIDE WOOD BLOCKING AT WALLS AS REQUIRED TO SUPPORT PIPING, CABINETS TV BRACKETS AND RELATED ITEMS.
- 8. ALL EGRESS DOORS SHALL BE NON-LOCKING IN DIRECTION OF TRAVEL.

### **DEMOLITION NOTES**

- 1. ALL WORK SHALL BE PERFORMED IN STRICT ACCORDANCE WITH ALL NATIONAL, STATE, LOCAL CODES & ORDINANCES.
- 2. THE DEMOLITION PLANS ARE DIAGRAMMATIC AND INTENDED TO SHOW THE GENERAL EXTENT OF THE WORK ONLY. THE CONTRACTOR SHALL INCLUDE ALL DEMOLITION WORK REQUIRED TO ACCOMPLISH THE INTENT OF THE PLANS AND SPECIFICATIONS.
- 3. ALL DEMOLISHED ITEMS SHALL BE REMOVED FROM BUILDING / SITE UNLESS NOTED OTHERWISE. COORDINATE WITH OWNER FOR DELIVERY OF ITEMS NOTED TO REMAIN OWNERS PROPERTY. THE PROJECT SITE / BUILDING SHALL BE CLEANED OF DEBRIS ON A DAILY BASIS.
- 4. CONTRACTOR SHALL BE RESPONSIBLE FOR SHORING AND SUPPORT (TEMPORARY OR PERMANENT) FOR ALL PORTIONS OF CONSTRUCTION DURING DEMOLITION AND CONSTRUCTION.
- 5. ALL ABANDONED MECHANICAL / ELECTRICAL / PLUMBING LINES SHALL BE CAPPED OFF BEHIND FINISHES, UNLESS NOTED OTHERWISE. REFER TO MECHANICAL / ELECTRICAL / PLUMBING DRAWINGS FOR ADDITIONAL INFORMATION.
- 6. CONTRACTOR SHALL SAWCUT ALL MASONRY OR CONCRETE OPENINGS INDICATED. MASONRY SHALL BE TOOTHED IN AND / OR RETURNED TO FINISHED OPENING.
- 7. ALL OPENINGS WHERE EXISTING CONSTRUCTION HAS BEEN REMOVED, AND WHICH ARE NOT NOTED TO REMAIN, SHALL BE FILLED AND / OR PATCHED TO MATCH THE ADJACENT EXISTING OR NEW FINISH, INCLUDING ANY FIRE RATINGS REQUIRED.
- 8. ALL AREAS OF FLOORS, WALLS AND CEILINGS DISTURBED BY DEMOLITION SHALL BE FILLED, PATCHED OR OTHERWISE REFINISHED TO MATCH EXISTING OR NEW FINISH AS DESIGNATED, INCLUDING ALL REQUIRED RATINGS.
- 9. CONTRACTOR MUST VERIFY LOCATIONS OF ALL EXISTING STRUCTURAL, MECHANICAL, PLUMBING & ELECTRICAL ELEMENTS PRIOR TO START OF DEMOLITION

### GENERAL NOTES

DIMENSION CRITERIA
 FROM FACE OF METAL STUD TO FACE OF METAL STUD.
 FROM FACE OF METAL STUD TO FACE OF CONCRETE MASONRY UNIT.
 FROM FACE OF CONCRETE MASONRY UNIT TO FACE OF CONCRETE MASONRY UNIT.

### FIRESTOPPING NOTES:

ALL PENETRATION FIRESTOPPING IS REQUIRED FOR ALL BUILDING LEVELS PERTAINING TO THE WORK ASSOCIATED WITH THESE CONTRACT DOCUMENTS. REFER TO SPECIFICATION SECTION 078413 - PENETRATION FIRESTOPPING, FIRE RATING PLAN, ASSOCIATED NOTES & DRAWINGS FOR EXTENT OF WORK

### CODE INFORMATION

Date of Original Construction 1964 Renovations	1995 - Re-Roofing
	2013 - Cooling Tower Roof
1. GROUP CLASSIFICATION (Primary)	B - BUSINESS A - ASSEMBLY
(Incidental)	S - STORAGE
2. CONSTRUCTION TYPE	
Actual Type Provided	2B
New Construction	None
3. WORK AREA	
(WORK AREA) Existing Roof Area to be Replaced	N/A
4. FIRE-RESISTANCE RATED REQUIREMENTS FOR BUILDING ELEMENTS (Table	·
4. FIRE-RESISTANCE RATED REQUIREMENTS FOR BUILDING ELEMENTS (Table  Primary structural frame	2B Hr(s)
	2B
Primary structural frame  Bearing walls:  Exterior	2B
Primary structural frame  Bearing walls:  Exterior Interior	2B
Primary structural frame  Bearing walls: Exterior Interior  Nonbearing walls and partitions (Exterior)	2B  0 Hr(s)  0 Hr(s) See Table 6 Hr(s) See Table 6
Primary structural frame  Bearing walls:     Exterior     Interior  Nonbearing walls and partitions (Exterior)  Nonbearing walls and partitions (Interior)	2B  0 Hr(s)  0 Hr(s) See Table 6  Hr(s) See Table 6  Hr(s) See Table 6  Hr(s) Hr(s)

### **CODE INFORMATION - CURRENT CODES**

\_\_\_\_X Provided

2021 International Building Code \*
2021 International Residential Code \*
2021 International Mechanical Code \*
2021 International Existing Building Code \*
2021 International Plumbing Code \*
2021 International Plumbing Code \*
2021 International Energy
Conservation Code \*
2020 National Electrical Code (NFPA 70) \*
2021 Installation of Sprinkler Systems (NFPA 13)
2021 International Fire Code \*
2021 International Swimming Pool & Spa Code \*
2021 Fire Code (NFPA 1) \*

\* With Connecticut Amendments and General Statute requirements

SPRINKLER PROTECTION

### INTERNATIONAL EXISTING BUILDING CODE

THE INTERNATIONAL EXISTING BUILDING CODE (IEBC)

CHAPTER 3: COMPLIANCE METHODS -

CHAPTER 3: Compliance Methods: Work Area Compliance Method per Section 301.1.2

CHAPTER 5: CLASSIFICATION OF WORK - Section 503 <u>Alteration Level 1</u>, 503.1 <u>Scope</u>. Level 1 alterations include the removal and replacement or the covering of existing materials, elements, equipment, or fixtures using new materials, elements, equipment, or fixtures that serve the same purpose.

503.2 Application - Level 1 Alterations shall comply with the provisions of Chapter 7

CHAPTER 7: The Alteration must comply with Chapter 7, Alterations - Level 1: Section 701 General - In Particular Section 701.1 Scope, Section 701.2 Conformance.


Section 702 Building Elements and Materials - In Particular Section 702.1 Interior Finishes, 702.2 Interior Floor Finish, 702.3 Interior Trim, 702.6 Materials and Methods


Section 703 Fire Protection

Section 704 Means of Egress

Section 705 Accessibility


By complying with the applicable requirements of Chapters 7 & the specific items referenced in Chapter 8 of the 2021 International Existing Building Code (IEBC) this alteration shall be considered in compliance.

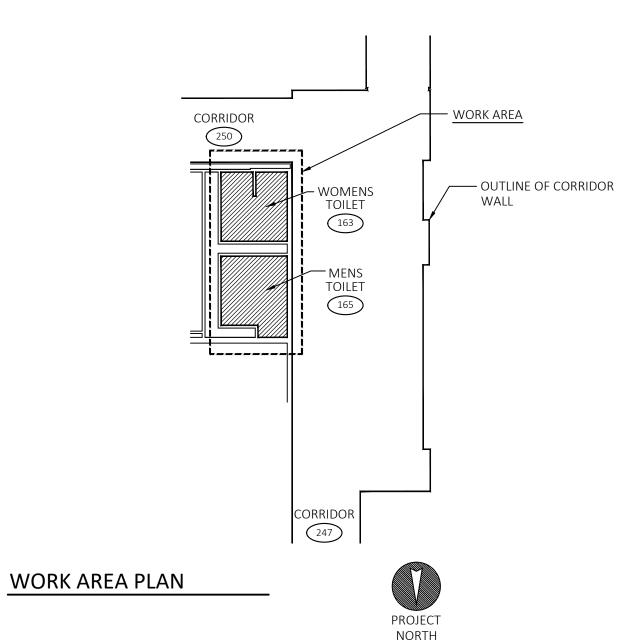

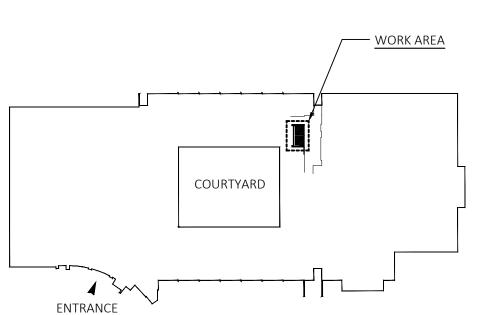

BUILDING KEY PLAN



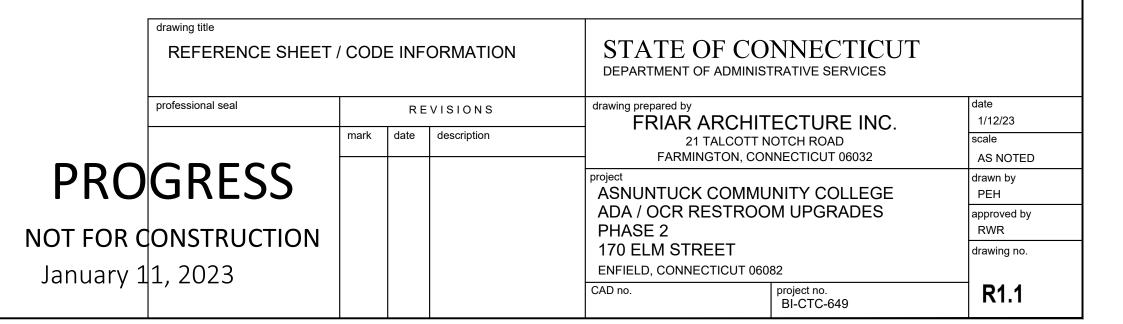

	CODE INFORMATION - OVERALL B  Date of Original Construction 1964 Renovation	
	GROUP CLASSIFICATION (Primary)	B - BUSINESS A - ASSEMBLY
	(Incidental)  CONSTRUCTION TYPE (Chapter 6)  Minimum Type Required:	S - STORAGE  2B
	Actual Type Provided: (existing)  (new)  BUILDING AREA (Chapter 5)  Building Area:	2B 2B
	Existing Construction Renovated Construction (Addition) Total Building  ACCESSIBLE BUILDING  X Designated	190,030 s.f. 27,236 s.f. 217,266 s.f.
	MINIMUM PLUMBING FIXTURE COUNT (IPC Chapter 4)  BASED ON OCCUPANT LOADS: ( E 5,158 p.)	
	EDUCATIONAL - E  Number Required  Water Closets  Lavatories  M 9 F 9  M 8 F 8	
	Urinals Drinking Fountains Service Sinks  5  2	
	BUSINESS - B  Number Required  Water Closets Lavatories  M 6 F 5  M 4 F 4	
	Urinals Drinking Fountains Service Sinks  TOTAL BUILDING COUNT (1ST & 2N  Number Requ  Water Closets M 20 F Lavatories Lavatories Urinals  5 Lavatories Urinals	
	ASSEMBLY - A-3  Number Required  Water Closets Lavatories  M 4 F 7 M 3 F 3  Drinking Fountains Service Sinks  17  5	Drinking Fountains Service Sinks  2
	Urinals Drinking Fountains Service Sinks	
	STORAGE - S  Number Required  Water Closets  Lavatories  Urinals	
	Lavatories  Urinals  Drinking Fountains  Service Sinks  M 1 F	
	SPRINKLER PROTECTIONX Entire Building Limited Area	
	CODES TO WHICH THIS PROJECT WAS DESIGNED  Original Building  State Building Code w/Supplement State Fire Code w/Supplement State Health Code  Original Building  1971 1971 Current	Addition         Current Review           2016         2022           2016         2022           Current         Current
	OSHA Current Section 504  ADA 1961 Other	Current 1973 w/current 1973 w/current amendment 2009 2017
	HEIGHT / AREA REQUIREMENTS  ACTUAL HT. UNCHANGED	
	ALLOW HT.  AREA, TOTAL BUILDING ALLOW AREA SEP NON-SEP OCC   UNCHANGED 217,266 S.F. UNLIMITED	
	CODE MODIFICATIONS ON FILE  MODIFICATION IBC SECTION TABLE 503 OF 2005 CT BUILDING CODE MODIFICATION IBC SECTION TABLE 503 OF 2005 CT BUILDING CODE	# M-247-13 # M-756-14A
	MODIFICATION IBC SECTION SECTION 502.3.1 OF 2009 IECC MODIFICATION IBC SECTION TEMPORARILY REDUCE EGRESS CAPACITY 2ND FL	# M-756-14B DOR # M-873-14
CURRENT 2022 STATE BUILDING CODE:		
CODE INFORMATION	drawing title	
2021 International Building Code *  2021 International Residential Code *  2021 International Existing Building Code *	CODE INFORMATION  professional seal REVISIONS	STATE OF CONNECTICUT DEPARTMENT OF ADMINISTRATIVE SERVICES  drawing prepared by FRIAR ARCHITECTURE INC.  date 1/12/23
Facilities (ICC A117.1-2017) *  2021 International Energy Conservation Code *  2020 National Electrical Code (NFPA 70) *  2019 Installation of Sprinkler Systems (NFPA 13) 2021 International Fire Code *  2021 Life Safety Code (NFPA 101) *  2021 International Swimming Pool & Spa Code *	PROGRESS mark date description	21 TALCOTT NOTCH ROAD FARMINGTON, CONNECTICUT 06032  project scale AS NOTED drawn by
2021 Fire Code (NFPA 1) *  * With Connecticut Amendments and General Statute requirements	NOT FOR CONSTRUCTION	PHASE 2  170 ELM STREET  approved by RWR drawing no.
	January 11, 2023	ENFIELD, CONNECTICUT 06082  CAD no.

### **DEMOLITION NOTES:**

- REMOVE ALL EXISTING TOILET PARTITIONS & ASSOCIATED HARDWARE FOR NEW FLOOR FINISH. REFER TO PLANS & SPECIFICATIONS FOR ADDITIONAL INFO.

  REFER TO (DEDUCT) ALTERNATE #X FOR REINSTALLATION OF EXISTING TOILET PARTITIONS
- REMOVE EXISTING DOOR & ASSOCIATED HARDWARE PREP FOR NEW DOOR & HARDWARE. RETAIN HOLLOW METAL DOOR FRAMES CLEAN & PREP FOR EPOXY PAINT SYSTEM & NEW DOOR HARDWARE.
- REMOVE ALL EXISTING WALL MOUNTED TOILET ROOM ACCESSORIES: MIRRORS, SHELVES, SOAP DISPENSERS, TOILET PAPER DISPENSERS, TOWEL HOOKS & WALL MOUNTED HARDWARE WITHIN BATHROOM AREAS. SALVAGE & TURN OVER TO OWNER FOR THEIR USE.
- REMOVE EXISTING WALL MOUNTED TOILET FIXTURE. REFER TO MEP DRAWINGS FOR ALL EXISTING ELECTRICAL / PLUMBING FIXTURES SCHEDULED FOR REMOVAL
- REMOVE EXISTING GRAB BARS LOCATED WITHIN THE TOILET ROOM AREAS. SALVAGE FOR OWNERS USE.
- REMOVE EXISTING WALL MOUNTED SINK FIXTURE. REFER TO MEP DRAWINGS FOR ALL EXISTING ELECTRICAL / PLUMBING FIXTURES SCHEDULED FOR REMOVAL
- REMOVE EXISTING CERAMIC TILE WALL SYSTEMS TO EXISTING MASONRY, PREP EXISTING MASONRY WALLS FOR INSTALLATION OF NEW CERAMIC TILE WALL SYSTEM (CWT).
- REMOVE EXISTING CERAMIC TILE FLOORING TO EXISTING CONCRETE FLOOR SYSTEM PREP EXISTING FLOOR SYSTEMS PER PORCELAIN TILE SYSTEM REQUIREMENTS FOR INSTALLATION OF NEW PORCELAIN TILE FLOOR SYSTEM (PT).
- EXISTING PLUMBING CHASE ACCESS PANELS & WALL MOUNTED DIFFUSERS CLEAN & PREP FOR EPOXY PAINT SYSTEM.

# CORRIDOR SCOPE OF WORK AREA WOMEN TOUES T

DEMO - FLOOR PLAN

### LE: 1/4"=1'-0"

### CONSTRUCTION NOTES:

- FURNISH & INSTALL NEW TOILET PARTITIONS & ASSOCIATED HARDWARE. REFER TO PLANS & SPECIFICATIONS FOR ADDITIONAL INFO.

  REFER TO (DEDUCT) ALTERNATE #X FOR REINSTALLATION OF EXISTING TOILET PARTITIONS
- FURNISH & INSTALL NEW DOOR & ASSOCIATED HARDWARE, REFER TO SPECIFICATIONS & DOOR SCHEDULE. RETAIN EXISTING HOLLOW METAL DOOR FRAMES, INSTALL NEW EPOXY PAINT SYSTEM REFER TO FINISH SCHEDULE & SPECIFICATIONS.
- FURNISH & INSTALL WALL MOUNTED TOILET ROOM ACCESSORIES: MIRRORS, SHELVES, SOAP DISPENSERS, TOILET PAPER DISPENSERS, TOWEL DISPENSERS, & WALL MOUNTED HARDWARE WITHIN BATHROOM AREAS. REFER TO SPECIFICATIONS & MOUNTING HEIGHT SCHEDULE FOR TOILET ACCESSORIES.
- furnish & install wall mounted toilet fixture. Refer to mep drawings for all electrical / plumbing fixtures scheduled for installation
- 5 FURNISH & INSTALL GRAB BARS IN THE TOILET ROOM AREAS. REFER TO SPECIFICATIONS & MOUNTING HEIGHT SCHEDULE FOR TOILET ACCESSORIES.
- FURNISH & INSTALL NEW VANITY & COUNTERTOP MOUNTED SINK FIXTURE. REFER CASEWORK DETAILS & FINISH SCHEDULE FOR VANITY. REFER TO MEP DRAWINGS FOR ALL EXISTING ELECTRICAL / PLUMBING FIXTURES SCHEDULED.
- FURNISH & INSTALL NEW CERAMIC TILE WALL (CWT) SYSTEM AND ASSOCIATED CERAMIC TILE BASE (CTB) AT EXISTING MASONRY WALL CONSTRUCTION. PREP EXISTING MASONRY WALL SYSTEM PER CERAMIC TILE SYSTEM REQUIREMENTS FOR INSTALLATION OF CERAMIC TILE WALL AND BASE. REFER TO FINISH SCHEDULE.
- FURNISH & INSTALL PORCELAIN TILE (PT) FLOORING SYSTEM AT EXISTING CONCRETE FLOOR CONSTRUCTION. PREP EXISTING FLOOR SYSTEMS PER PORCELAIN TILE SYSTEM REQUIREMENTS FOR INSTALLATION OF NEW PORCELAIN TILE FLOOR SYSTEM. REFER TO FINISH SCHEDULE
- PAINT EXISTING PLUMBING CHASE ACCESS PANELS & WALL MOUNTED DIFFUSERS, REFER TO FINISH SCHEDULE

### GENERAL DEMOLITION NOTES

PREP ALL CMU WALL AREAS FOR WALL FINISHES, TYP.

PREP ALL FLOOR AREAS FOR NEW FLOORING, TYP.


REMOVE & SALVAGE ALL EXISTING TOILET ACCESSORIES SCHEDULED FOR DEMO. CONSULT OWNER & TURN OVER TO THE OWNER ALL TOILET ACCESSORIES DEEMED ACCEPTABLE, TYPICAL AT ALL BATHROOMS. CONTRACTOR TO DISPOSE OF TOILET ACCESSORIES NOT ACCEPTABLE TO THE OWNER


### **GENERAL NOTE**

PROVIDE FLOOR PROTECTION AT EXISTING CORRIDOR. REFER TO FINISH SCHEDULE FOR ADDITIONAL INFORMATION

PROVIDE TEMPORARY PROTECTION FOR EXISTING FIRE SUPPRESSION


HEADS.

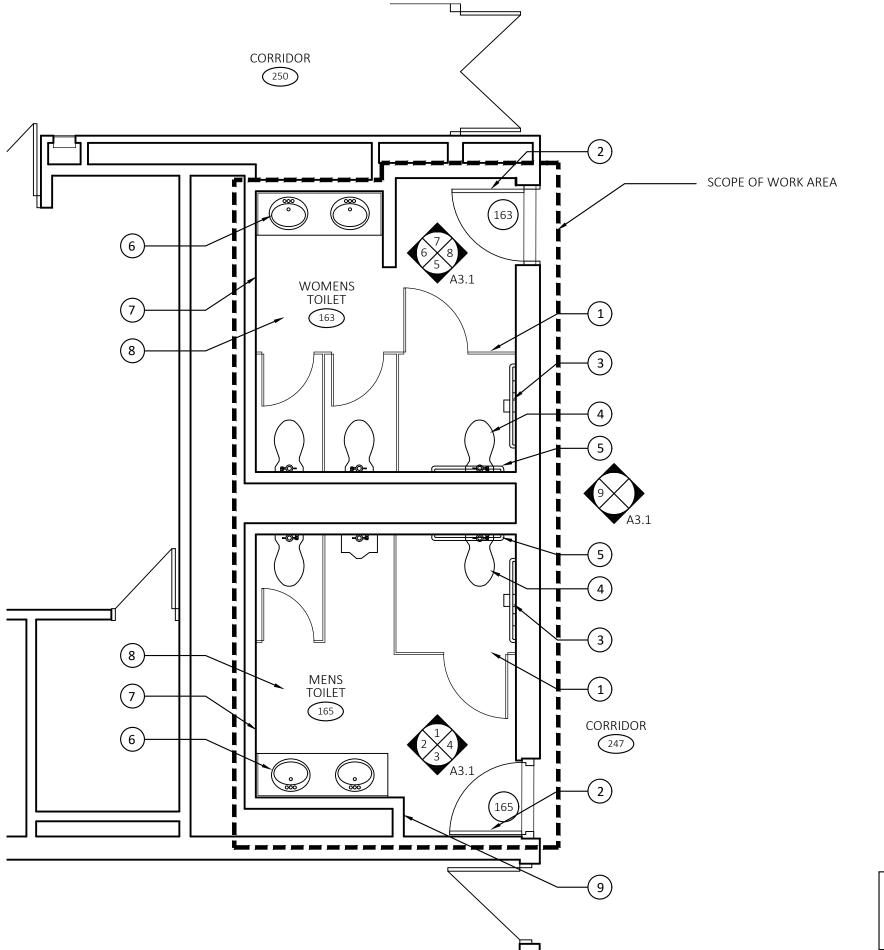

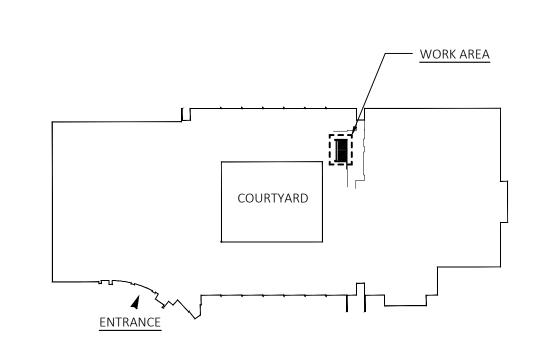

BUILDING KEY PLAN



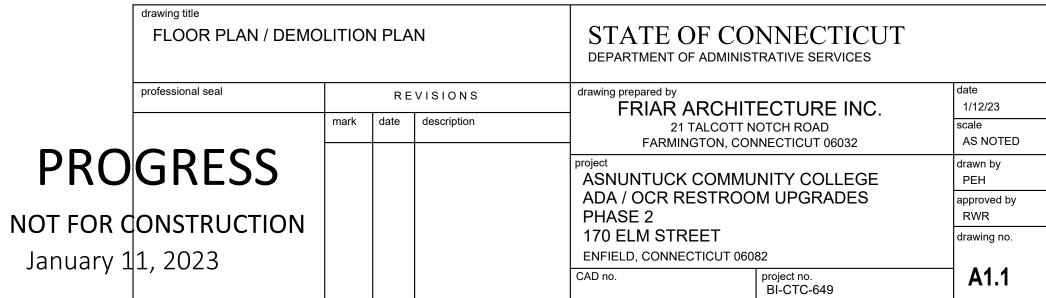


PROJECT NORTH


NEW WORK - FLOOR PLAN

SCALE: 1/4"=1'-0"


**CEILING DEMOLITION NOTES:** ADD ALTERNATE KEYED TO DEMO CEILING PLAN ADD ALTERNATE ADD ALTERNATE - REMOVE EXISTING SUSPENDED ACOUSTICAL CEILING TILE. CLEAN & PREP CEILING GRID FOR NEW PAINT FINISH CEILING TYPE SCHEDULE ADD ALTERNATE A 2' X 2' ACOUSTICAL CEILING TILE. BASIS OF DESIGN: ARMSTRONG ULTIMA HIGH NRC ITEM NO. 1941 - 15/16" BEVELED TEGULAR, FINE TEXTURE PANEL SIZE 24" X 24" X 7/8" TO FIT IN EXISTING CEILING GRID. **CEILING GENERAL NOTES:** ALL WORK SHALL BE PERFORMED IN STRICT ACCORDANCE WITH ALL NATIONAL, STATE, LOCAL CODES & ORDINANCES. REFER TO M/E/P DRAWINGS FOR CEILING FIXTURE TYPES, REQUIRED WORK, AND FOR OTHER CEILING MOUNTED EQUIPMENT NOT INDICATED ON THESE DRAWINGS. CUT CEILING TILES AS REQUIRED FOR INSTALLATION AROUND NEW OR EXISTING PIPING, FIRE ALARM EQUIPMENT,

HANGER RODS, CONDUIT, ETC.

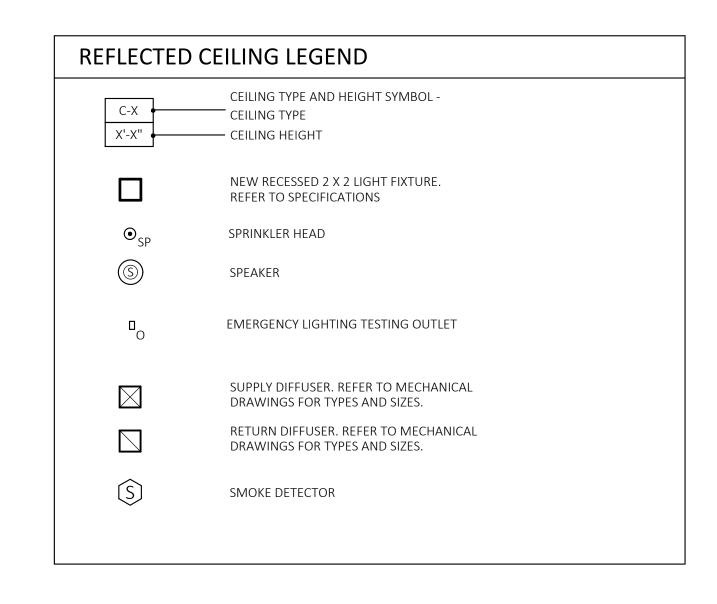

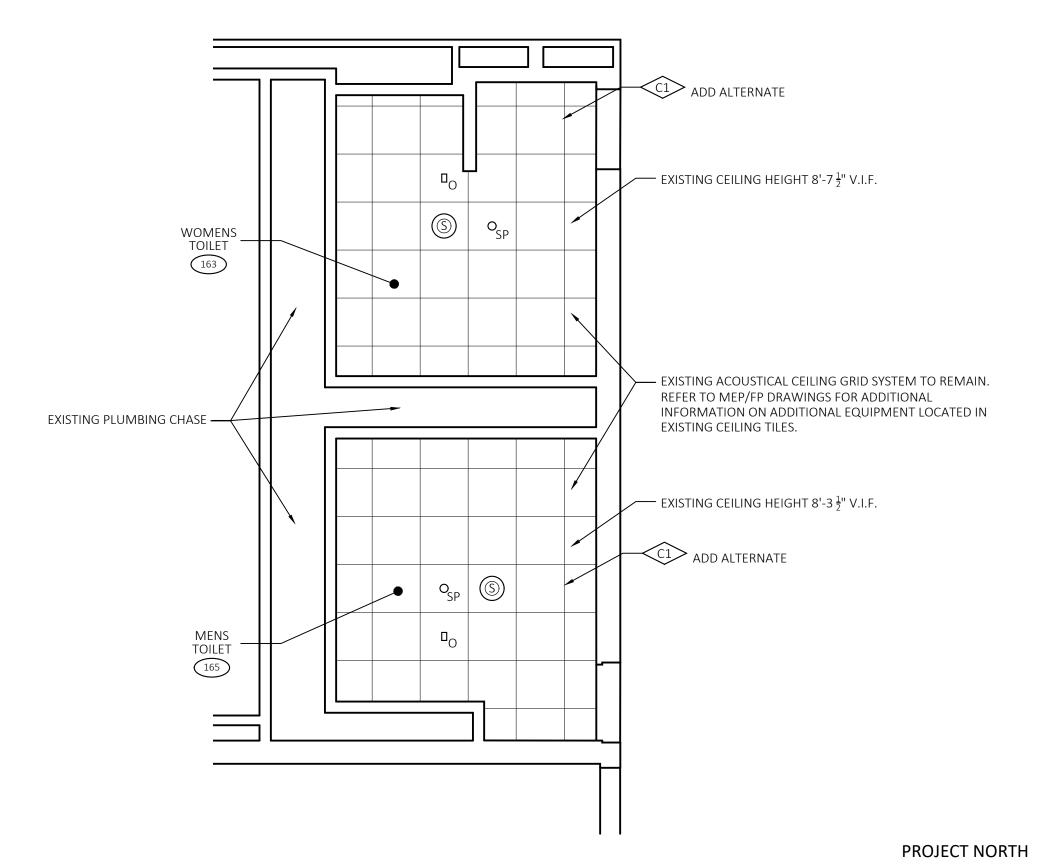




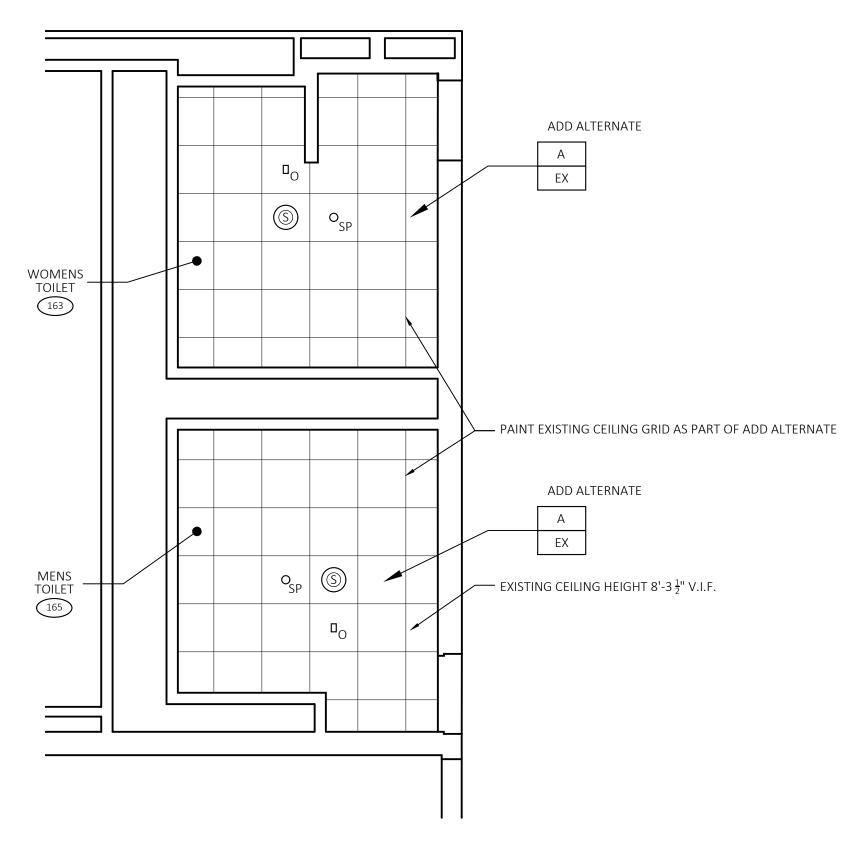

NEW WORK - REFLECTED CEILING PLAN


SCALE: 1/4"=1'-0"

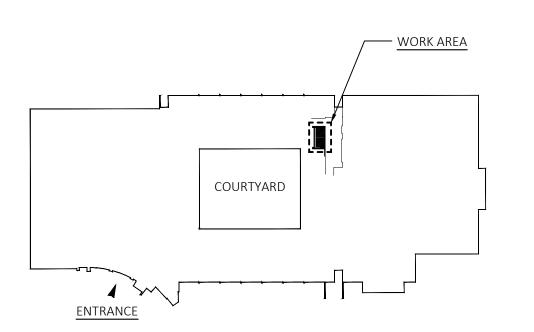



**BUILDING KEY PLAN** 




	drawing title REFLECTED CEILING	PLAN	I		STATE OF CONNECTICUT DEPARTMENT OF ADMINISTRATIVE SERVICES	
	professional seal		RE	VISIONS	drawing prepared by FRIAR ARCHITECTURE INC.	date 1/12/23
		mark	date	description	21 TALCOTT NOTCH ROAD FARMINGTON, CONNECTICUT 06032	scale AS NOTED
PRO	GRESS				project ASNUNTUCK COMMUNITY COLLEGE	drawn by PEH
NOT FOR C	ONSTRUCTION				ADA / OCR RESTROOM UPGRADES PHASE 2	approved by RWR
January 1	1, 2023				170 ELM STREET ENFIELD, CONNECTICUT 06082  CAD no. project no. BI-CTC-649	A2.1

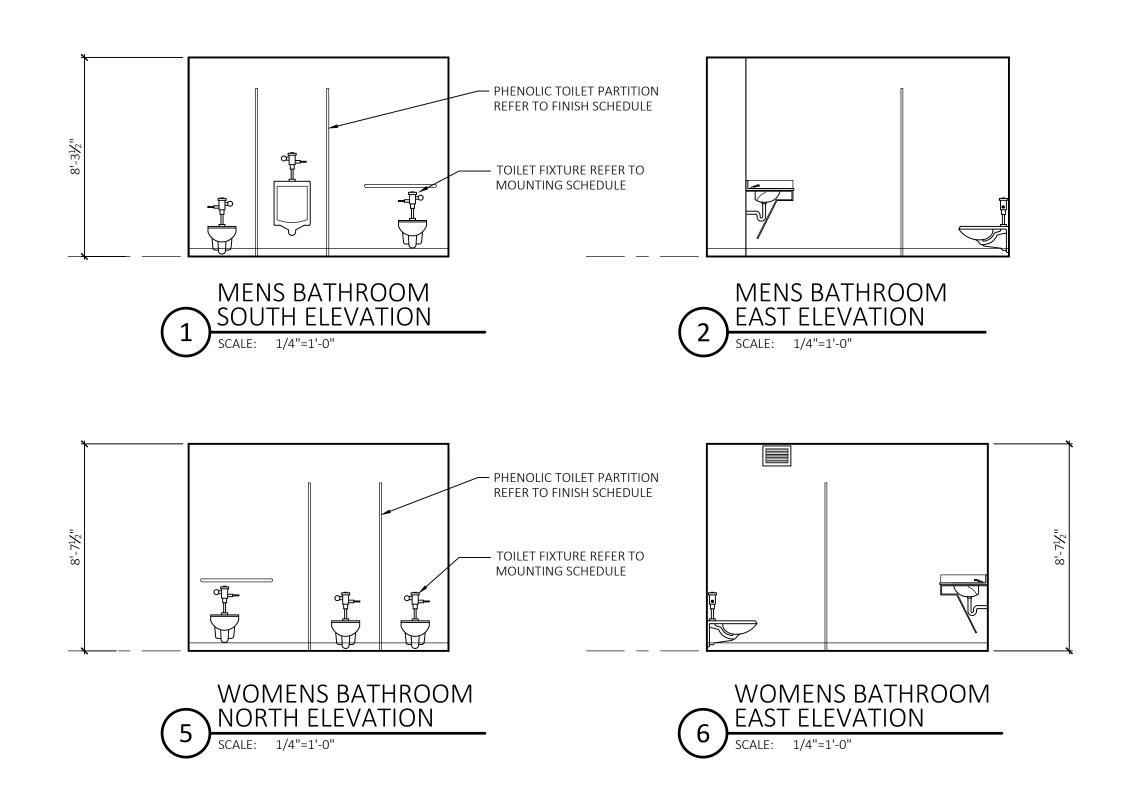


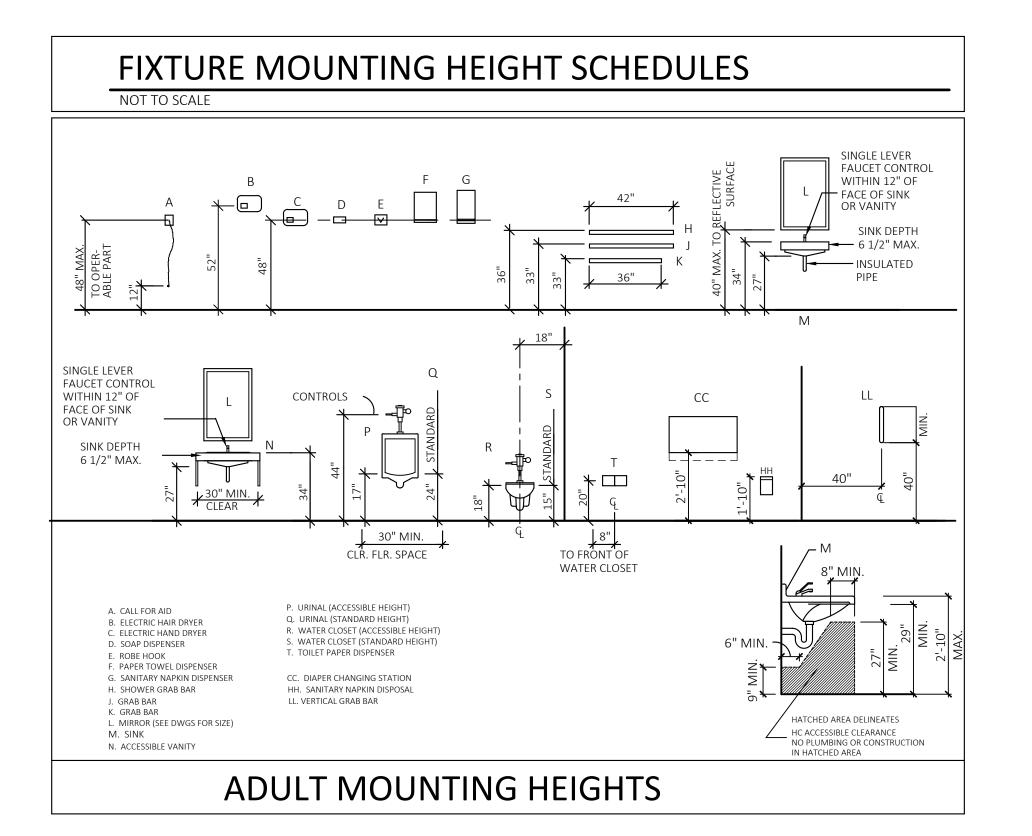


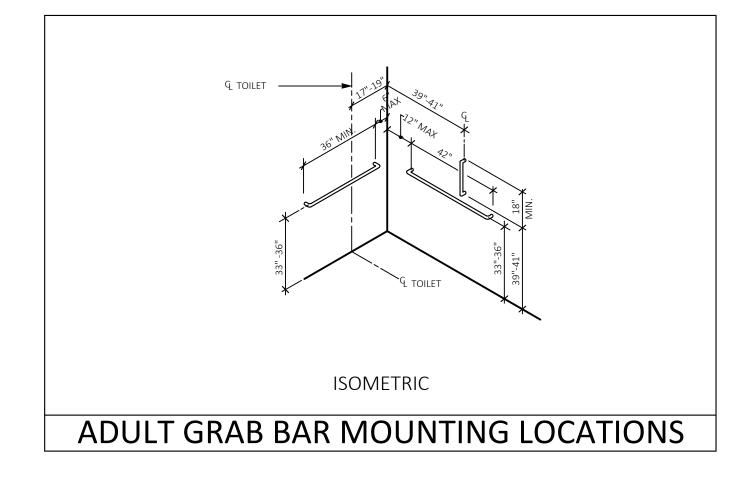

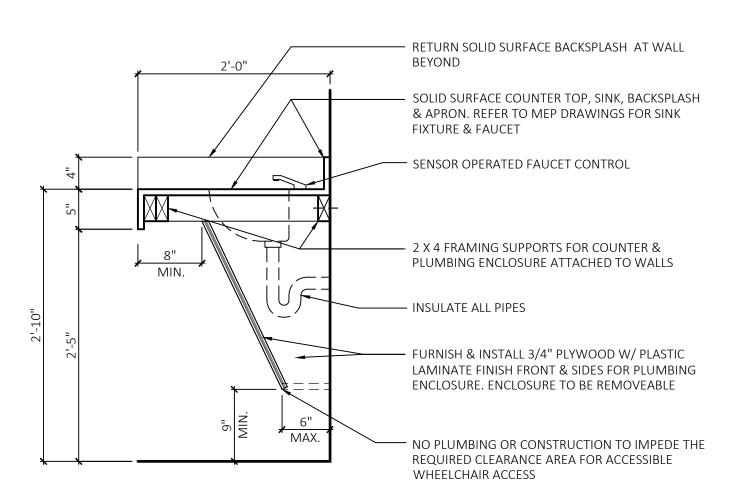



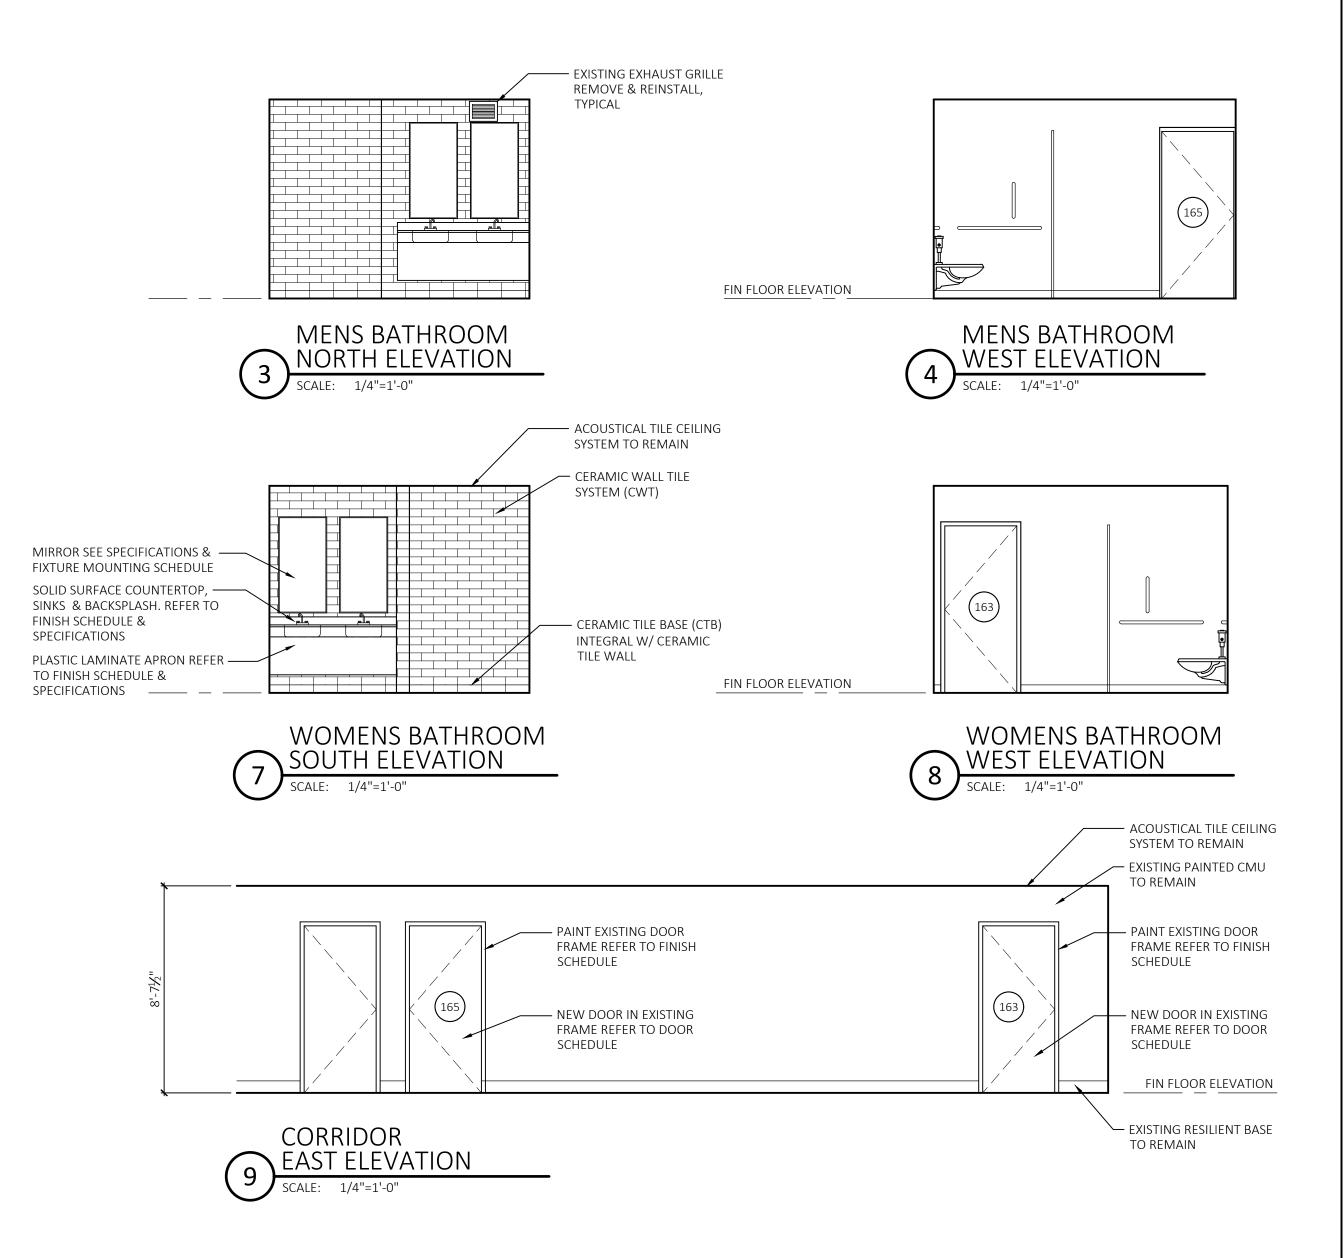

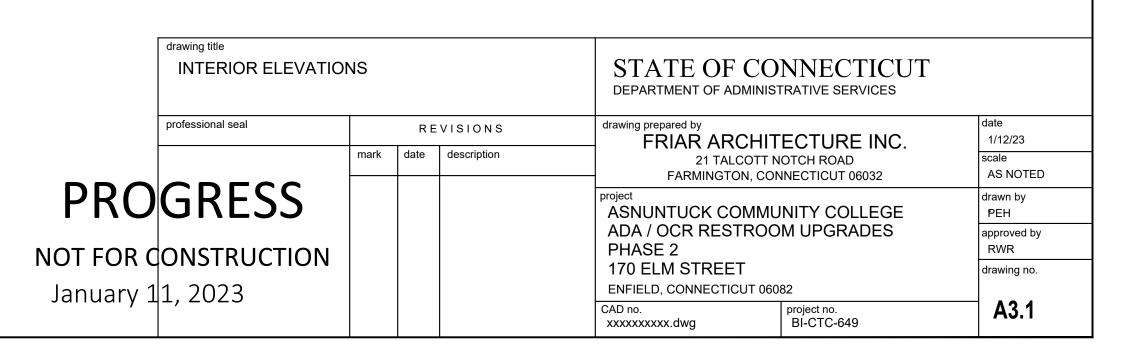

### **GENERAL REMARKS:**

- 1. ALL NEW COUNTERTOPS TO HAVE SOLID SURFACE (SS).
- 2. REFER TO DOOR SCHEDULE FOR EXISTING TO REMAIN DOOR FRAMES. FRAMES SHALL BE PRIMED AND PAINTED AS INDICATED IN SPEC SECTION 099100.


### FLOOR FINISH NOTES:

- 1. REFER TO FINISH SCHEDULE FOR COLOR DESIGNATIONS.
- 2. ALL FLOOR FINISHES TO EXTEND TO MEET WALL AND/OR BASE OF CASEWORK.
- 3. FINISH PLAN SHOULD BE USED IN CONJUNCTION WITH FINISH SCHEDULE. SHOULD THERE BE ANY DISCREPANCY BETWEEN OTHER DRAWINGS IN THE SET, THE HIGHER QUALITY FINISH SHALL BE PROVIDED.

ACT - ACOUSTICAL TILE CEILING  HC - HANDICAPPED  CT - CERAMIC FLOOR TILE  P - PAINT  CTB - CERAMIC TILE BASE  PT - PORCELAIN FLOOR TILE  CTR - COUNTER  R/R - REMOVE & REINSTALL  CWT - CERAMIC WALL TILE  RB - RESILIENT BASE  EP - EPOXY PAINT  SS - SOLID SURFACE  EX-EP - EXISTING EPOXY  T - THRESHOLD / CURB  EX-T - EXISTING TERRAZZO FLOOR  TF - TERRAZZO FLOORING  GB - GRAB BAR  TP - TOILET PARTITIONS  GT - GROUT		ABBREVI	ATIO	NS
	CT CTB CTR CWT EP EX-EP EX-T GB	- CERAMIC FLOOR TILE - CERAMIC TILE BASE - COUNTER - CERAMIC WALL TILE - EPOXY PAINT - EXISTING EPOXY - EXISTING TERRAZZO FLOOR - GRAB BAR	P PT R/R RB SS T TF	- PAINT - PORCELAIN FLOOR TILE - REMOVE & REINSTALL - RESILIENT BASE - SOLID SURFACE - THRESHOLD / CURB - TERRAZZO FLOORING - TOILET PARTITIONS

### TYPICAL NEW CERAMIC TILE WALL FINISH SYSTEMS

INSTALL CERAMIC TILE SYSTEM WALL SYSTEM TYPICAL. REFER TO FINISH SCHEDULE

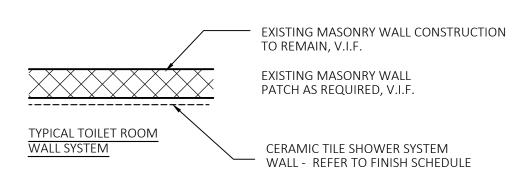

### TILE SYSTEMS:

EXISTING CONCRETE FLOOR

REFER TO SPECIFICATION SECTION 093000 - TILING FOR ADDITIONAL INFO

ITEM - TILE / GROUT - TYPICAL AT ALL NEW TOILET ROOM LOCATIONS DESCRIPTION: SPECTRALOCK PRO PREMIUM GROUT, MANUFACTURER LATICRETE INTERNATIONAL, INC., HIGH PERFORMANCE GROUT. REFER TO SCHEDULE FOR GROUT

ITEM - TILE / FLOOR UNDERLAYMENT MIX - TYPICAL AS REQUIRED AT NEW PORCELAIN TILE FLOOR. DESCRIPTION: TCC TILE CRETE TO BE USED AS A SETTING BED & UNDERLAYMENT TO ALLOW FOR LEVELING & SMOOTH SURFACE FOR PORCELAIN TILE INSTALLATION OVER

M - MIRRORS - REFER TO INTERIOR ELEVATIONS SHEET A3.1

MANUFACTURER; BOBRICK WASHROOM EQUIPMENT, INC. DESCRIPTION: MIRROR W/ STAINLESS STEEL CHANNEL FRAME, MODEL NO. B-165 2448, SIZE 24" X 48"

### **EP- EPOXY PAINT**

MANUFACTURER; SHERWIN WILLIAMS COLOR #SW - TO BE DETERMINED LOCATION - TOILET ROOM DOOR FRAMES (TOILET & CORRIDOR SIDES)

MANUFACTURER; SHERWIN WILLIAMS COLOR #SW - TO BE DETERMINED LOCATION - EXISTING CEILING GRID AS PART OF ADD

### TP- TOILET PARTITIONS

TP MANUFACTURER; ASI GLOBAL PARTITIONS FLOOR ANCHORED OVERHEAD BRACED PHENOLIC COLOR THRU PANELS REFER TO FLOOR PLAN FOR SIZES / QUANTITY LOCATION - TOILET ROOM, TOILET & URINAL ENCLOSURES

### CT- CERAMIC TILE

MANUFACTURER: CROSSVILLE INC. RETRO ACTIVE 2.0 AND PATTERNS COLOR: EMPRESS WHITE LOCATION - TOILET ROOM BASE - SIZE 6" X 12" COVE FINISH POLISHED (PO)

MANUFACTURER: CROSSVILLE INC. RETRO ACTIVE 2.0 AND PATTERNS LOCATION - TOILET ROOM WALL - SIZE 4" X 12" (SUBWAY TILE) FINISH POLISHED (PO)

### PT- PORCELAIN FLOOR TILE

MANUFACTURER: CROSSVILLE INC. RETRO ACTIVE 2.0 AND PATTERNS COLOR: TO BE DETERMINED LOCATION - TOILET ROOM FLOOR - SIZE 12" X 12" FINISH UNPOLISHED W/ CROSS-SHEEN (UPS)

### GT- GROUT

MANUFACTURER: LATICRETE COLOR: TO BE DETERMINED LOCATION - NEW TOILET ROOM FLOORS

MANUFACTURER: LATICRETE COLOR: TO BE DETERMINED LOCATION - NEW TOILET ROOM WALLS

### SS- SOLID SURFACE - COUNTER TOPS & BACKSPLAH

MANUFACTURER: CORIAN COLOR: COTTAGE LANE LOCATION - NEW TOILET ROOM COUNTERS

### PL- PLASTIC LAMINATE

MANUFACTURER: FORMICA COLOR: TO BE DETERMINED

LOCATION - NEW TOILET ROOM PLUMBING ENCLOSURES

### FP- TEMPORARY FLOOR & WALL PROTECTION

FP MANUFACTURER; RAM BOARD MODEL # S-21372 SIZE: 38" X 100' ROLLS PRESSURE SENSITIVE KRAFT TAPE LOCATION - CORRIDOR FLOORS AND STAIR FLOORS - REFER TO KEY PLAN FOR TYPICAL LOCATIONS

# - EXISTING MARBLE DOOR THRESHOLD TO REMAIN. PROTECT EXISTING MARBLE THRESHOLD & EXISTING TERRAZZO FLOOR CONSTRUCTION AT CORRIDOR, TYPICAL EXISTING PIPE CHASE —— - EXISTING WALL CONSTRUCTION REFER TO FLOOR PLAN TOILET 163 TOILET 165 CORRIDOR 247 EXISTING PIPE CHASE ———

FINISH SCHEDULE

SOUTH

CWT-1

CWT-1

NORTH

CWT-1

CWT-1

EAST

CWT-1

CWT-1

WEST

CWT-1

CWT-1

SS-1 | TP-1 |

## FINISH PLAN PROJECT

### FINISH FLOOR LEGEND:

MISCELLANEOUS

SS-1 | TP-1 | EX | EP-1 | PL-1 | EX | GB |ACT-1 | EP-2 |

EP-1

EX | EP-1 | PL-1 | EX | GB | ACT-1 | EP-2 |




### **FINISH NOTES:**

1. CONTRACTOR SHALL PATCH AND REPAIR EXISTING SURFACES WHERE NECESSARY TO CREATE A SMOOTH AND CONTINUOUS SURFACE PRIOR TO INSTALLING NEW FINISHES AND PRIOR TO PAINTING EXISTING SURFACES.

REMARKS

FLOOR PROTECTION - AS REQ'D

- 2. CAULK ALL JOINTS BETWEEN CEILING SURFACES & WALL SURFACES.
- 3. EXISTING FLOOR COVERING SHALL BE REMOVED TO ALLOW FOR NEW CONSTRUCTION. CONTRACTOR SHALL PROTECT EXISTING FINISHES TO REMAIN FROM DAMAGE DURING PROJECT. FLOORS ARE TO BE PREPARED TO ACCEPT NEW MATERIALS AS INDICATED ON PLAN.
- 4. THE CONTRACTOR SHALL BE RESPONSIBLE FOR VENTILATING THE AREA IN WHICH CONSTRUCTION IS TAKING PLACE TO REMOVE CONTAMINANTS PRODUCED BY OUT-GASSING OF NEW MATERIALS, THE USE OF ADHESIVES AND SOLVENTS, AND ALL OTHER CONSTRUCTION ACTIVITIES. VENTILATION OF THE SPACE SHALL BE ACCOMPLISHED WITHOUT ALLOWING AIR EXHAUSTED FROM THE CONSTRUCTION AREA TO INFILTRATE ANY OTHER PORTION OF THE FLOOR OR BUILDING. THE METHOD TO BE EMPLOYED SHALL BE APPROVED BY OWNER'S REPRESENTATIVE BEFORE IMPLEMENTATION.
- 5. THE CONTRACTOR SHALL ONLY USE ADHESIVE THAT IS ENVIRONMENTALLY SAFE AND CONTAINS NO SOLVENTS, ALCOHOL, GLYCOL, AMMONIA OR CARCINOGENS AND MUST BE A LOW V.O.C.
- 6. ALL EXPOSED MECHANICAL, ELECTRICAL, PLUMBING AND FIRE PROTECTION EQUIPMENT WITHIN THE SCOPE OF WORK AREAS ARE TO RECEIVE A PAINT FINISH. REFER TO SPECIFICATION SECTION 099123 - INTERIOR PAINTING FOR PAINT SYSTEM. PAINT COLOR TO MATCH NEW ADJACENT WALL OR CEILING FINISH.

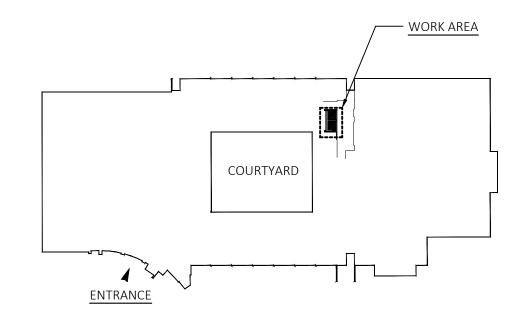

**BUILDING KEY PLAN** 



							MISCELL	ANEOUS	5					INDICATES OWNER PROVIDED AND CONTRACTOR INSTALLED
								ACLE						<ul> <li>INDICATES CONTRACTOR PROVIDED AND CONTRACTOR INSTALLED</li> </ul>
ROOM NUMBER AREA DESIGNATION	ROOM OR	LL MIRROR	CTRIC HAND DRYER	PKIN DISPOSAL	PER TOWEL DISPENSER	LET PAPER DISPENSER	AP DISPENSER	EE STANDING TRASH RECEPT	MPON/NAPKIN DISPENSER	LET PARTITIONS	ELF / BASKET	OKS	STIC NOTICE HOLDER CK OF STALL DOOR)	REUSE EXISTING - REMOVE AND REINSTALL ON NEW FINISHES
RO	AREA NAME	WA	ELE	NAI	PAF	TOIL	80/	FRE	TAN	TOILE	SHE	오	PLA (BA	REMARKS

TOILET ROOM ACCESSORIES SCHEDULE

AR	AREA NAIVIE	7M	1T3	AN	PA	10	SO	FR	TA	OT	HS	ЭН	PL, (B/	REMARKS
.63	WOMENS TOILET	•	•	•	0	0	0	0	•	•	•	•	•	
.65	MENS TOILET	•	•	-	0	0	0	0	-	•	•	•	•	

VIEW FROM TABLE 803.9/ 2012 IBC INTERIOR WALL AND CEILING FINISH REQUIREMENTS BY OCCUPANCY

INTERIOR WITCH CEL	LING THUSTI NEQUINEIVIET	115 BT OCCOTATION				
		SPRINKLERE	)	NC	NSPRINKLER	RED
GROUP	VERTICAL EXITS & EXIT PASSAGEWAYS	EXIT ACCESS CORRIDORS & OTHER EXITWAYS	ROOMS AND ENCLOSED SPACES	VERTICAL EXITS & EXIT PASSAGEWAYS	EXIT ACCESS CORRIDORS & OTHER EXITWAYS	ROOMS AND ENCLOSED SPACES
A-1 & A-2	В	В	С	А	А	В
A-3, A-4, A-5	В	В	С	A	A	С
В, Е, М	В	С	С	A	В	С

INTERIOR WALLS AND CEILING FINISHES SHALL BE CLASSIFIED IN ACCORDANCE WITH ASTM E 84.

ROOM OR AREA NAME

PT-1

PT-1

TF-EX

FP

CTB-1

CTB-1

RB-EX

**WOMENS TOILET** 

MENS TOILET

CORRIDOR

CORRIDOR

163

165

247

247

**PROGRESS** 

professional seal

January 11, 2023

STATE OF CONNECTICUT FINISH PLAN, SCHEDULE, & DETAILS DEPARTMENT OF ADMINISTRATIVE SERVICES REVISIONS FRIAR ARCHITECTURE INC. 1/12/23 mark date description 21 TALCOTT NOTCH ROAD FARMINGTON, CONNECTICUT 06032 AS NOTED ASNUNTUCK COMMUNITY COLLEGE ₽ΕΗ ADA / OCR RESTROOM UPGRADES approved by PHASE 2 NOT FOR CONSTRUCTION RWR 170 ELM STREET drawing no. ENFIELD, CONNECTICUT 06082 **A4.1** project no. BI-CTC-649

										DOO	R SCH	IEC	DU	LE					
		DESCR OF W	IPTION /ORK		DOOR	R		FRAME	Ξ				SE		RDW <i>A</i> ECIFIC		NS	SIGNAGE TEXT	
NUMBER	3 & FRAME	3 / EXISTING FRAME		WIDTH	HEIGHT	AL/TYPE		DETAIL	DETAIL	RATING	IOLD DETAIL				ACCESSIBLE THRESHOLD  TINUJOUS GFARED HINGE / FULL HT.		- HINGE COVER PLATES		<ul> <li>○ INDICATES EXISTING CONDITION</li> <li>● INDICATES REQUIRED WORK</li> <li>● REUSE EXISTING - REMOVE FROM EXISTING AND INSTALL ON NEW</li> </ul>
DOOR	NEW DOOR & FRAME	NEW DOOR,		DOOR W	DOOR H	MATERIAL	TYPE	HEAD D	JAMB D	FIRE RA	THRESHOLD	KEYED DEADBOLT	AUTO CLOSER	12" HIGH KICK PLATES	H.C. ACCESSIB	DOOR SILENCERS	BLANK STRIKE PLATE DOOR BUMPER	MOUNTING HEIGHT:  60" O.C. ABOVE FINISH FLOOR	REMARKS
162	•				71.011			ı		i		ial			<u> </u>	I		T WOMEN'S TOWER	<u></u>
163	-			3'-0"	7'-0"	SCW-1	EX	-	-	-	EX				_	-		WOMENS TOILET	
165				3'-0"	7'-0"	SCW-1	EX	-	-	-	EX	-			0	<u>'                                     </u>		MENS TOILET	

# DOOR SCHEDULE / PRODUCT INFO:

BASIS OF DESIGN INFORMATION -

CONTINUOUS GEARED HINGE MANUFACTURER: STANLEY SECURITY SOLUTIONS
COLOR / FINISH: ALUMINUM -TO BE DETERMINED
ITEM NO: 661 HD - HEAVY DUTY FOR FLUSH FRAME
APPLICATIONS, SIZE: 79" LONG
LOCATION - BATHROOM DOORS

PUSH/PULL DOOR HARDWARE MANUFACTURER: DONJO MFG., INC.
COLOR / FINISH: STAINLESS STEEL SIZE:4"WIDE X 16"
HIGH ITEM NO: CFK7115115, VERIFY WITH OWNER IF
HOLES ARE REQUIRED
LOCATION - BATHROOM DOORS

PULL DOOR HARDWARE DOOR 165 MANUFACTURER: ASSA ABLOY
COLOR / FINISH: STAINLESS STEEL
SIZE: 5" WIDE X 5" HIGH X 7/8" DEEP
ITEM NO: ROCKWOOD BF97L - BARRIER FREE FLUSH
PULLS W/ SECURITY TORX SCREWS
LOCATION - BATHROOM DOORS


DOOR CLOSER MANUFACTURER: SARGENT (ASSA ABLOY)
TOP JAMB APPLICATIONS 351 SERIES POWERGLIDE DOOR CLOSER:
FINISH: 626, COMPLETE UNIT W/ MOUNTING PLATE
LOCATION - BATHROOM DOORS

DOOR SILENCERS -MANUFACTURER: DK HARDWARE SUPPLY COLOR: GRAY ITEM NO: SR64BG LOCATION - BATHROOM DOORS

BLANK STRIKE PLATE MANUFACTURER: DONJO MFG., INC.
COLOR / FINISH: PAINT TO MATCH FRAME
ITEM NO: BS 161, SIZE: 4-78 X 1-1/4"
LOCATION - BATHROOM DOOR FRAMES

DOOR BUMPER MANUFACTURER: IVES
COLOR / FINISH: SATIN CHROME FINISH
ITEM NO: WS 406/407 CCV 2-1/2" DIA.
CONCAVE WALL BUMPER
MOUNTING: MASONRY WALL MOUNTING KIT
LOCATION - BATHROOM WALLS AT DOOR PULL
SIDE


DOOR KICKPLATE MANUFACTURER: IVES
COLOR / FINISH: STAINLESS STEEL, SIZE: 12" X 34"
ITEM NO: 8400
LOCATION - BATHROOM DOORS

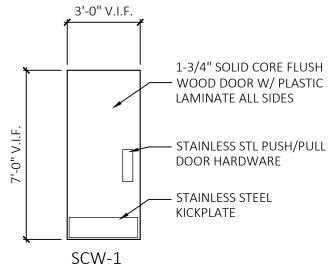

TYPICAL INTERIOR WOOD DOOR - BATHROOM DOORS (SCW-1):

36" X 84" SOLID CORE DOOR. VERIFY IN FIELD ALL EXISTING DIMENSIONS & COORDINATE INSTALLATION PRIOR TO ORDERING DOORS & HARDWARE

### **DOOR TYPES**

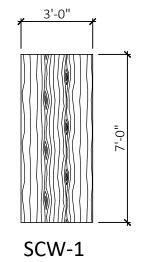

### DOOR / HARDWARE NOTES


DOOR HARDWARE SUPPLIER/MANUFACTURER MUST PROVIDE SUFFICIENT REINFORCING FOR ALL DOOR HARDWARE.


INSTALLERS WILL MAKE ANY FINAL ADJUSTMENTS TO ASSURE THE SMOOTH OPERATION OF THE DOOR & DOOR HARDWARE

CONTRACTOR TO COORDINATE DOOR HARDWARE/ LOCKSMITH CONTRACTOR TO UPDATE EXISTING DOOR HARDWARE FOR OWNER AS REQUIRED


ALL DOORS IN MASONRY WALLS TO BE UNDERCUT %" VERIFY IN FIELD BEFORE ORDERING DOORS

SCRAPE & SAND METAL DOOR FRAME AS REQUIRED TO ALLOW SMOOTH OPERATION OF THE DOOR & DOOR HARDWARE

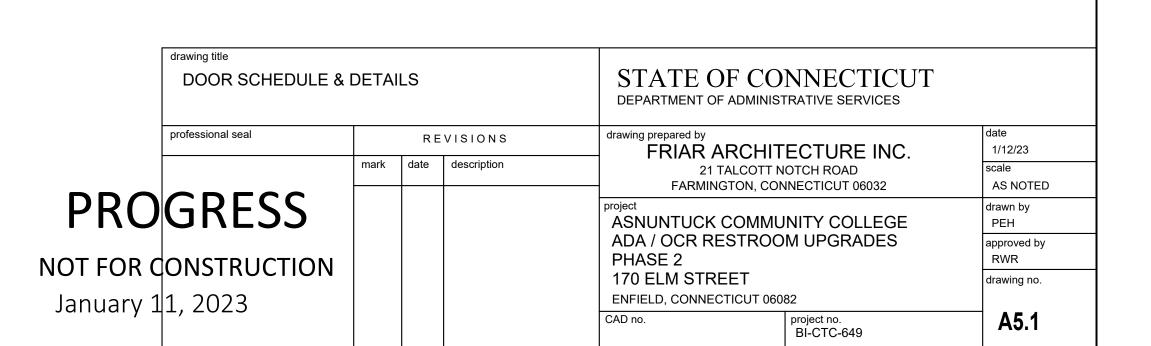

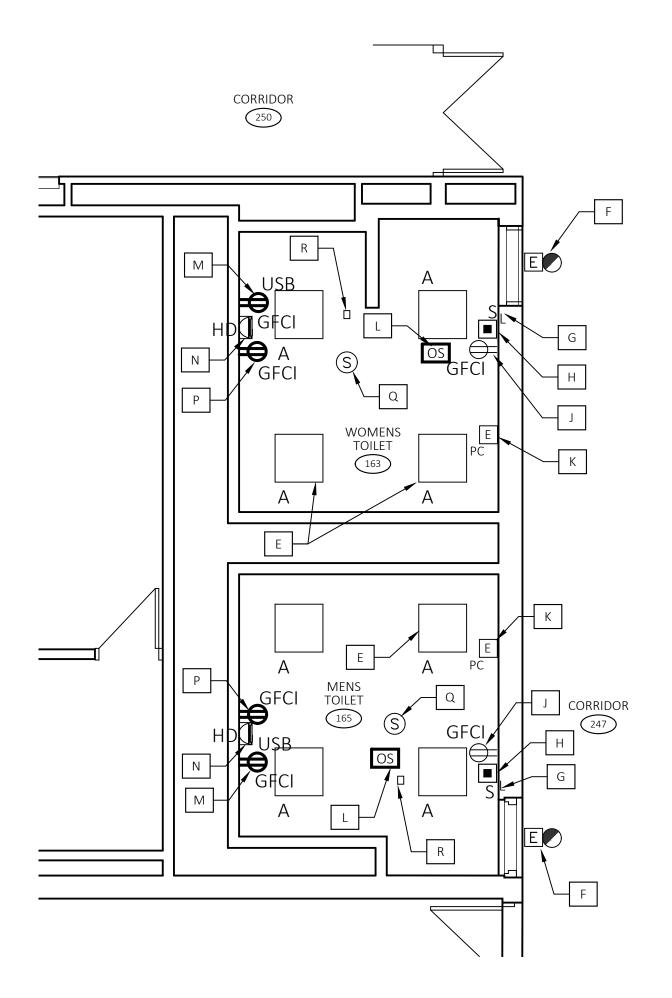

# NEW WORK - ELECTRICAL FLOOR PLAN SCALE: 1/4"=1'-0"

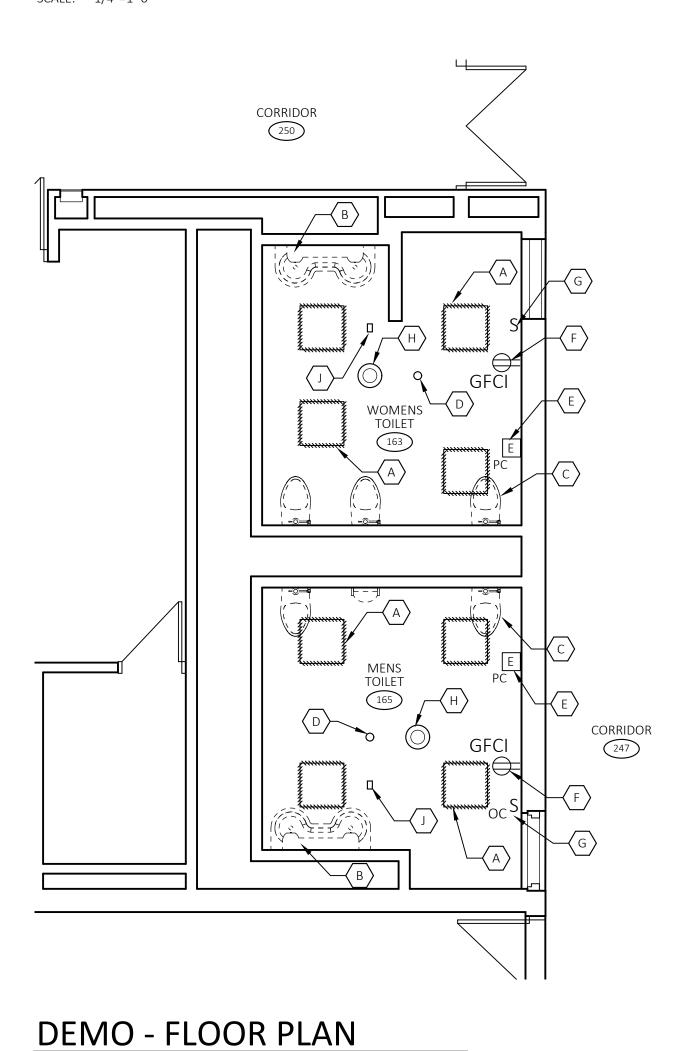

SCALE: 1/4"=1'-0"



### DEMOLITION CALLOUT NOTES

- REMOVE AND RETAIN EXISTING 2' X 2' LIGHT FIXTURES FOR TURN-OVER TO OWNER. RETAIN EXISTING WIRING FOR INSTALLATION OF NEW 2' X 2' FIXTURES AND DEVICES.
- B REMOVE AND RETAIN EXISTING "BRADLEY TYPE SINK FOR TURN-OVER TO OWNER. RETAIN AND PROTECT ALL PIPING FOR INSTALLATION OF NEW LAVATORIES.
- C REMOVE AND RETAIN EXISTING WATER CLOSETS AND URINAL FOR TURN-OVER TO OWNER. RETAIN AND PROTECT ALL PIPING FOR INSTALLATION OF NEW WATER CLOSETS AND URINAL.
- REMOVE EXISTING PENDENT SPRINKLER HEADS. PREP FOR INSTALLATION OF NEW CONCEALED SPRINKLER HEADS.
- REMOVE, RETAIN AND PROTECT EXISTING CALL FOR AID PULL STATION FOR RE-INSTALLATION UPON COMPLETION OF FINISHES.

F REMOVE, RETAIN AND PROTECT EXISTING DUPLEX RECEPTACLE FOR RE-INSTALLATION UPON COMPLETION

- OF FINISHES.

  G REMOVE EXISTING SWITCH, RETAIN WIRING FOR INSTALLATION OF NEW SWITCH.
- H REMOVE, RETAIN AND PROTECT EXISTING SPEAKER FOR RE-INSTALLATION IN NEW CEILING TILES. RETAIN EXISTING WIRING.
- $\langle I \rangle$  NOT IN USE.
- REMOVE, RETAIN AND PROTECT EXISTING TEST DEVICE FOR RE-INSTALLATION IN NEW CEILING TILES. RETAIN EXISTING WIRING.

### **NEW WORK CALLOUT NOTES**

- A FURNISH AND INSTALL NEW UNDERCOUNTER LAVATORIES. (SEE SCHEDULE) TYP. X 4
- B FURNISH AND INSTALL NEW WATER CLOSETS.
  INSTALLATION AS PER ANSI A117.1, 2017. (SEE SCHEDULE) TYP. X 5
- C FURNISH AND INSTALL NEW URINAL. (SEE SCHEDULE)
- D FURNISH AND INSTALL NEW CONCEALED SPRINKLER HEAD WITH WHITE COVER PLATE.
- E FURNISH AND INSTALL NEW 2' X 2' LED LIGHT FIXTURES. TIE INTO EXISTING WIRING. ( SEE SCHEDULE)
- F EXISTING VISUAL CALL FOR AID DEVICE TO REMAIN.
- G FURNISH AND INSTALL NEW SWITCH. (SEE ELECTRICAL LEGEND)
- H FURNISH AND INSTALL NEW FIRE ALARM STROBE, COMPATIBLE WITH EXISTING FIRE ALARM SYSTEM.
- I NOT IN USE.
- J REINSTALL GFCI RECEPTACLE.
- K REINSTALL EXISTING CALL FOR AID PULL STATION IN ORIGINAL LOCATION.
- L FURNISH AND INSTALL NEW CEILING MOUNTED OCCUPANCY SENSOR. WIRE TO NEW FIXTURES.
- M FURNISH AND INSTALL NEW GFCI RECEPTACLE FOR ELECTRIC HAND DRYER.
- N FURNISH AND INSTALL NEW ELECTRIC HAND DRYER. (SEE SCHEDULE)
- O NOT IN USE.
- P FURNISH AND INSTALL NEW DUAL RECEPTACLE/USB ASSEMBLY. (SEE ELECTRICAL LEGEND)
- Q REINSTALL EXISTING SPEAKER, FURNISH AND INSTALL ADDITIONAL WIRING/FITTINGS AS NECESSARY.
- R REINSTALL EXISTING TEST DEVICE.
- S RECONNECT ALL PLUMBING FIXTURES TO EXISTING HOT WATER, COLD WATER AND SANITARY PIPING. SUPPLY ALL NECESSARY PIPE, VALVES AND FITTINGS NECESSARY FOR PROPER RE-CONNECTION. INSULATE AS REQUIRED.

ELECTRICAL NOTE:
ALL SURFACE MOUNTED DEVICES TO BE
SUPPLIED BY WIRING RUN WITHIN SURFACE
MOUNTED RACEWAY. PROVIDE AND INSTAL
RACEWAY, BOXES, FITTINGS AND HANGERS.


### PLUMBING FIXTURE SCHEDULE


### PLUMBING FIXTURE NOTES:

- THE PLUMBING SUBMITTALS SHALL HAVE ALL EQUIPMENT/FIXTURES AND ASSOCIATED TRIM IDENTIFIED AS INDICATED BELOW FOR APPROVAL. ALL FIXTURES AND EQUIPMENT SHALL BE AS SPECIFIED OR EQUAL.
- 2. THE PLUMBING CONTRACTOR SHALL PROVIDE AND INSTALL ALL NECESSARY TRIM (ADAPTERS, SUPPLIES, STOPS, TRAPS, FITTINGS, CONNECTORS, COUPLING, ETC.) TO MAKE FINAL CONNECTION AND INSTALL A COMPLETE SYSTEM.
- 3. ALL HANDICAP FIXTURES SHALL BE INSTALLED PER ANSI A117.1, 2017.
- 4. REFER TO THE ARCHITECTURAL DRAWINGS FOR FIXTURE MOUNTING HEIGHTS AND EXACT LOCATIONS.


TYPE	FIXTURE	SOIL/ WASTE	VENT	HOT WATER	COLD WATER	MOUNTING	DESCRIPTION
WC1H	WATER CLOSET	4"	2"	-	1/2"	WALL	AMERICAN STANDARD, " AFWALL MILLENNIUM" FLUSHOMETER TOILET, MODEL # 2257.101, ELONGATED, TOP SPUD, WHITE, VITREOUS CHINA WITH DC POWER MODEL # 121.002 SENSOR OPERATED, 1.28 GPF FLUSHOMETER AND MODEL # 5901.100 OPEN FRONT WHITE SEAT.
UR1	URINAL	2"	1½"	-	<del>½</del> "	WALL	AMERICAN STANDARD, "WASHBROOK" FLOWISE 0.5 GPF HIGH EFFICIENCY URINAL, MODEL # 6590.001, W/ 0.5 GPF TOP SPUD AND DC POWER SELECTRONIC SENSOR OPERATED FLUSH VALVE, MODEL #6063.051.002, WHITE VITREOUS CHINA.
	LAVATORY	1½"	1½"	½"	½"	UNDER COUNTER	AMERICAN STANDARD "OVALYN" UNIVERSAL ACCESS UNDERCOUNTER, MODEL # 9482.000, WHITE, VITREOUS CHINA, SELECTRONIC ELECTRONIC PROXIMITY FAUCET, MODEL # 6055.104, 4" DECK PLATE MODEL # 605P.400 AND OPTIONAL MIXING VALVE, MODEL # 605XTMV1070 COMPLETE WITH FLEXIBLE HOSES AND COMPRESSION FITTINGS. FURNISH WITH TRUEBRO LAV GUARD 2E-Z SERIES COVERS.

	LI	GHTING/EQUIPMENT FIXTU	RE SC	HEDUL	E	
TYPE	SYMBOL	DESCRIPTION	VOLTS	MOUNTING	LAN	
					TYPE	WATTS
А		2' x 2' LED RECESSED TROFFER, WHITE FINISH, FROSTED ACRYLIC LENS, LED DRIVER. COLUMBIA LIGHTING MODEL # LJT22-35MLG-FSA12125F-EU.	120	RECESSED	LED	35
HD		XLERATOR HAND DRYER, MODEL # XL-SB, BRUSHED STAINLESS STEEL. 8 SECOND DRY TIME, 39 - 64 CFM	120	SURFACE	-	-

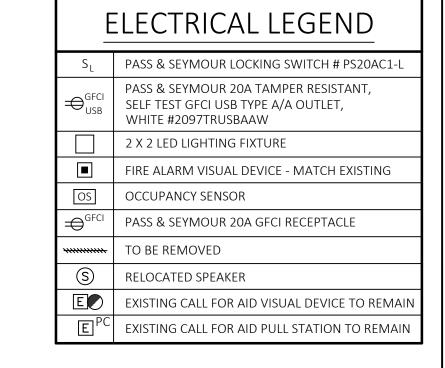

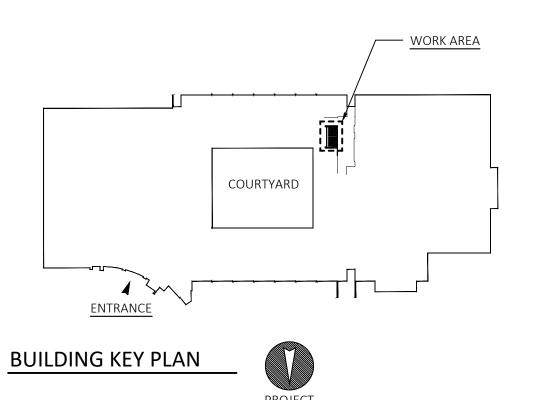

	drawing title FLOOR PLAN / DEMOLITION PLAN				i	STATE OF CONNECTICUT DEPARTMENT OF ADMINISTRATIVE SERVICES				
	professional seal	REVISIONS				drawing prepared by FRIAR ARCHITECTURE INC.			date 1/12/23	
	GRESS ONSTRUCTION 2, 2023	mark	date	description		21 TALCOTT NOTCH ROAD FARMINGTON, CONNECTICUT 06032			scale AS NOTED	
PRO					project ASNUNTUCK COMMUNITY COLL			drawn by PEH	=	
T FOR C					· -	ADA / OCR RESTROOM UPGRADES PHASE 2 170 ELM STREET ENFIELD, CONNECTICUT 06082			approved by RWR	
									drawing no.	
					CAD no.		project no. BI-CTC-649		MEP1.1	

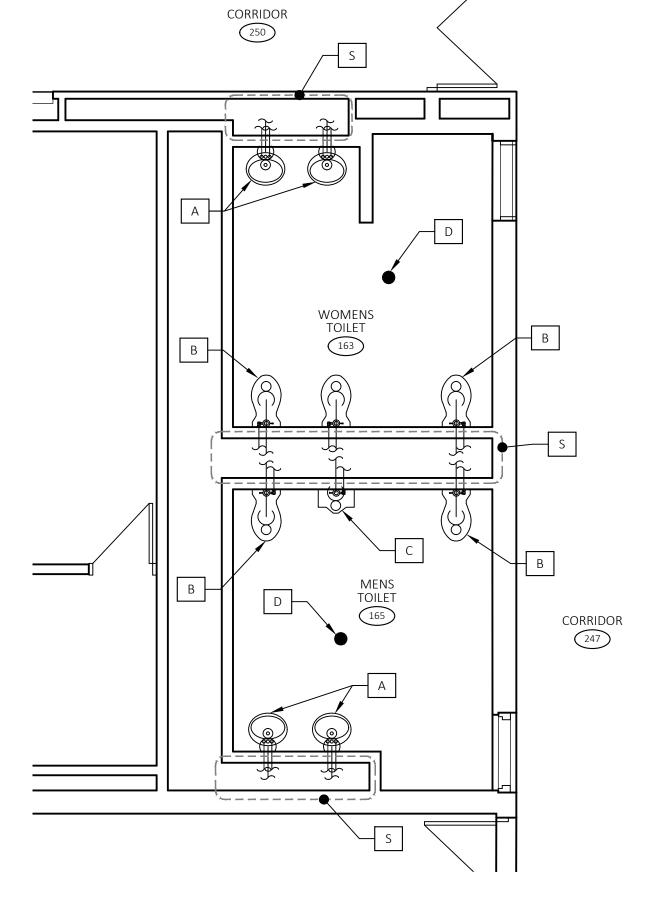

NEW WORK - M/P/FP FLOOR PLAN